

KEY PLAN CAR PARK

REVISED DEVELOPMENT APPLICATION SUBMISSION DEVELOPMENT APPLICATION SUBMISSION

Westmead Catholic Community

Darcy Road, Westmead

Catholic Education Diocese of Parramatta

DEVELOPMENT APPLICATION

	,
drawn:	N
checked:	LE
verified:	ce
sheet size:	A 1
scale:	1:1000
50	80m
	checked: verified: sheet size: scale:

LOCATION PLAN sheet

19122 project_no.



KEY PLAN CAR PARK

REVISED DEVELOPMENT APPLICATION SUBMISSION DEVELOPMENT APPLICATION SUBMISSION

TAPPLICATION LB 16.07.2020 SUBMISSION N SUBMISSION LB 31.03.2020

subject p.a


ALLEANZA ARCHITECTUR

Westmead Catholic Community

Darcy Road, Westmead


Catholic Education Diocese of Parramatta


DEVELOPMENT APPLICATION

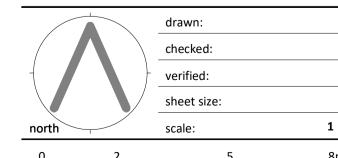

SITE PLAN sheet

19122 CP-DA-001 sheet_no.

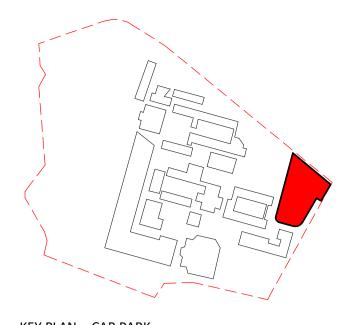


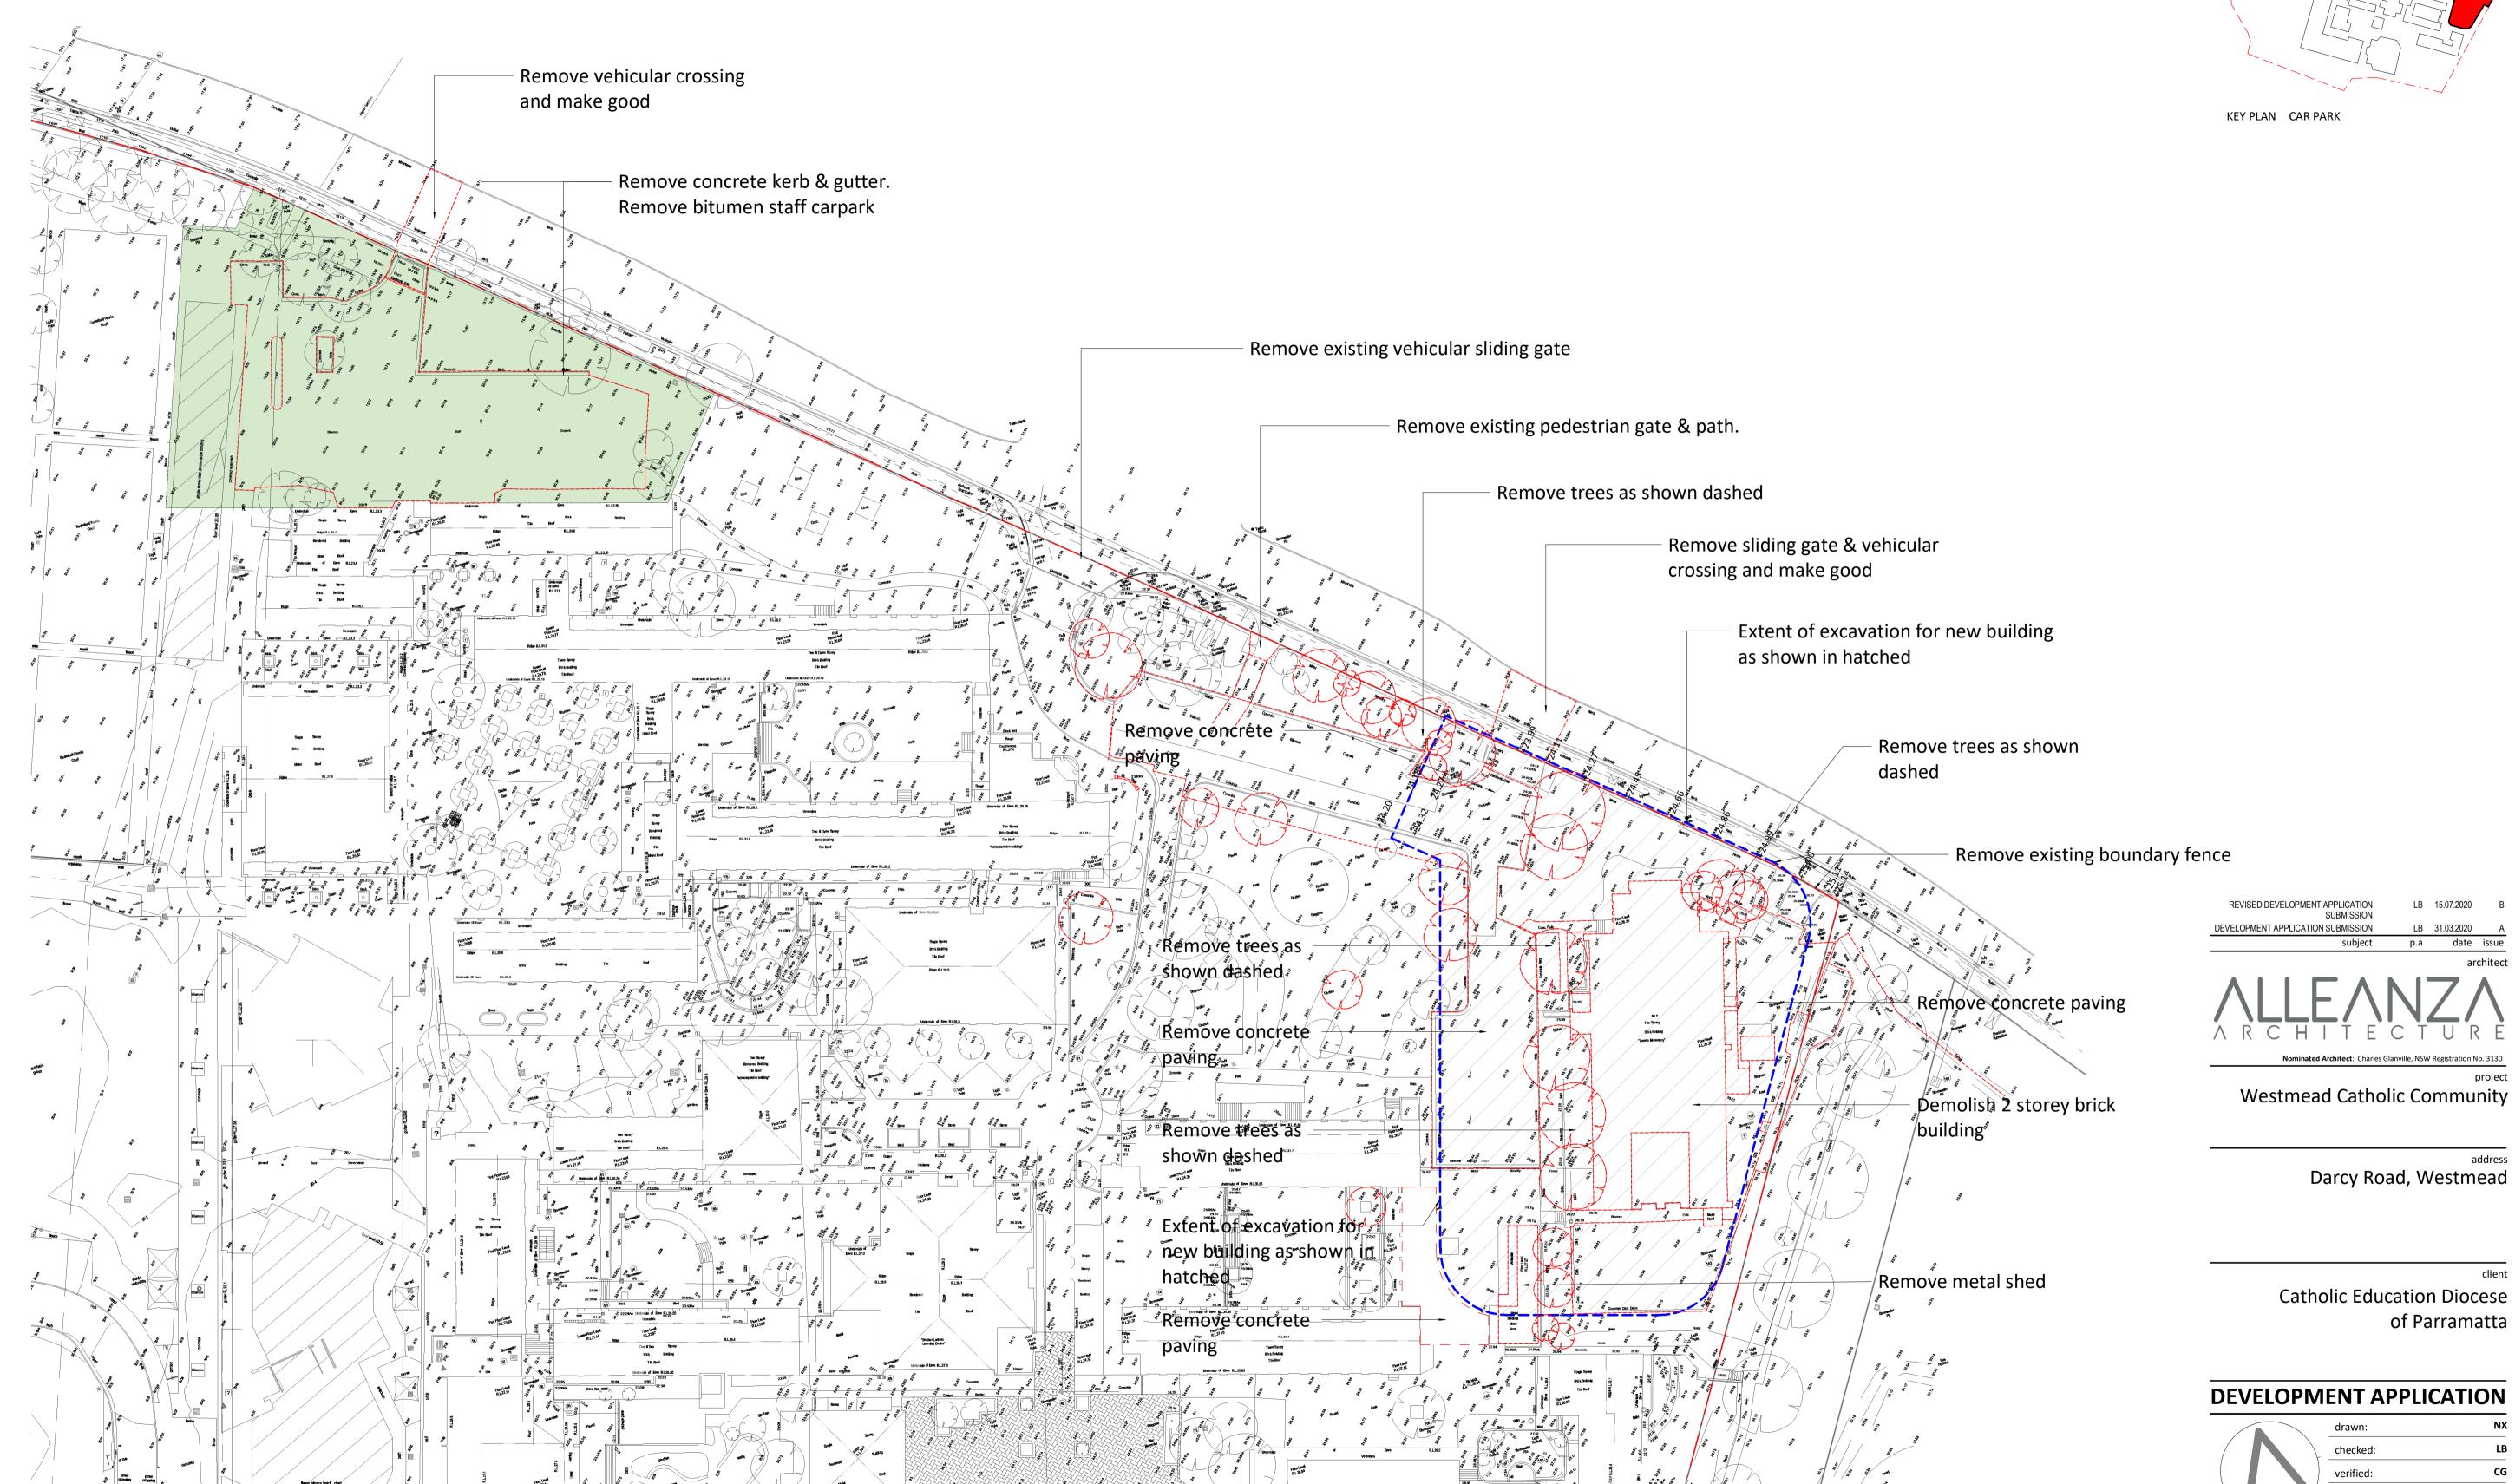


DEVELOPMENT APPLICATION

DEMOLITION PLAN

19122 project_no. CP-DA-003

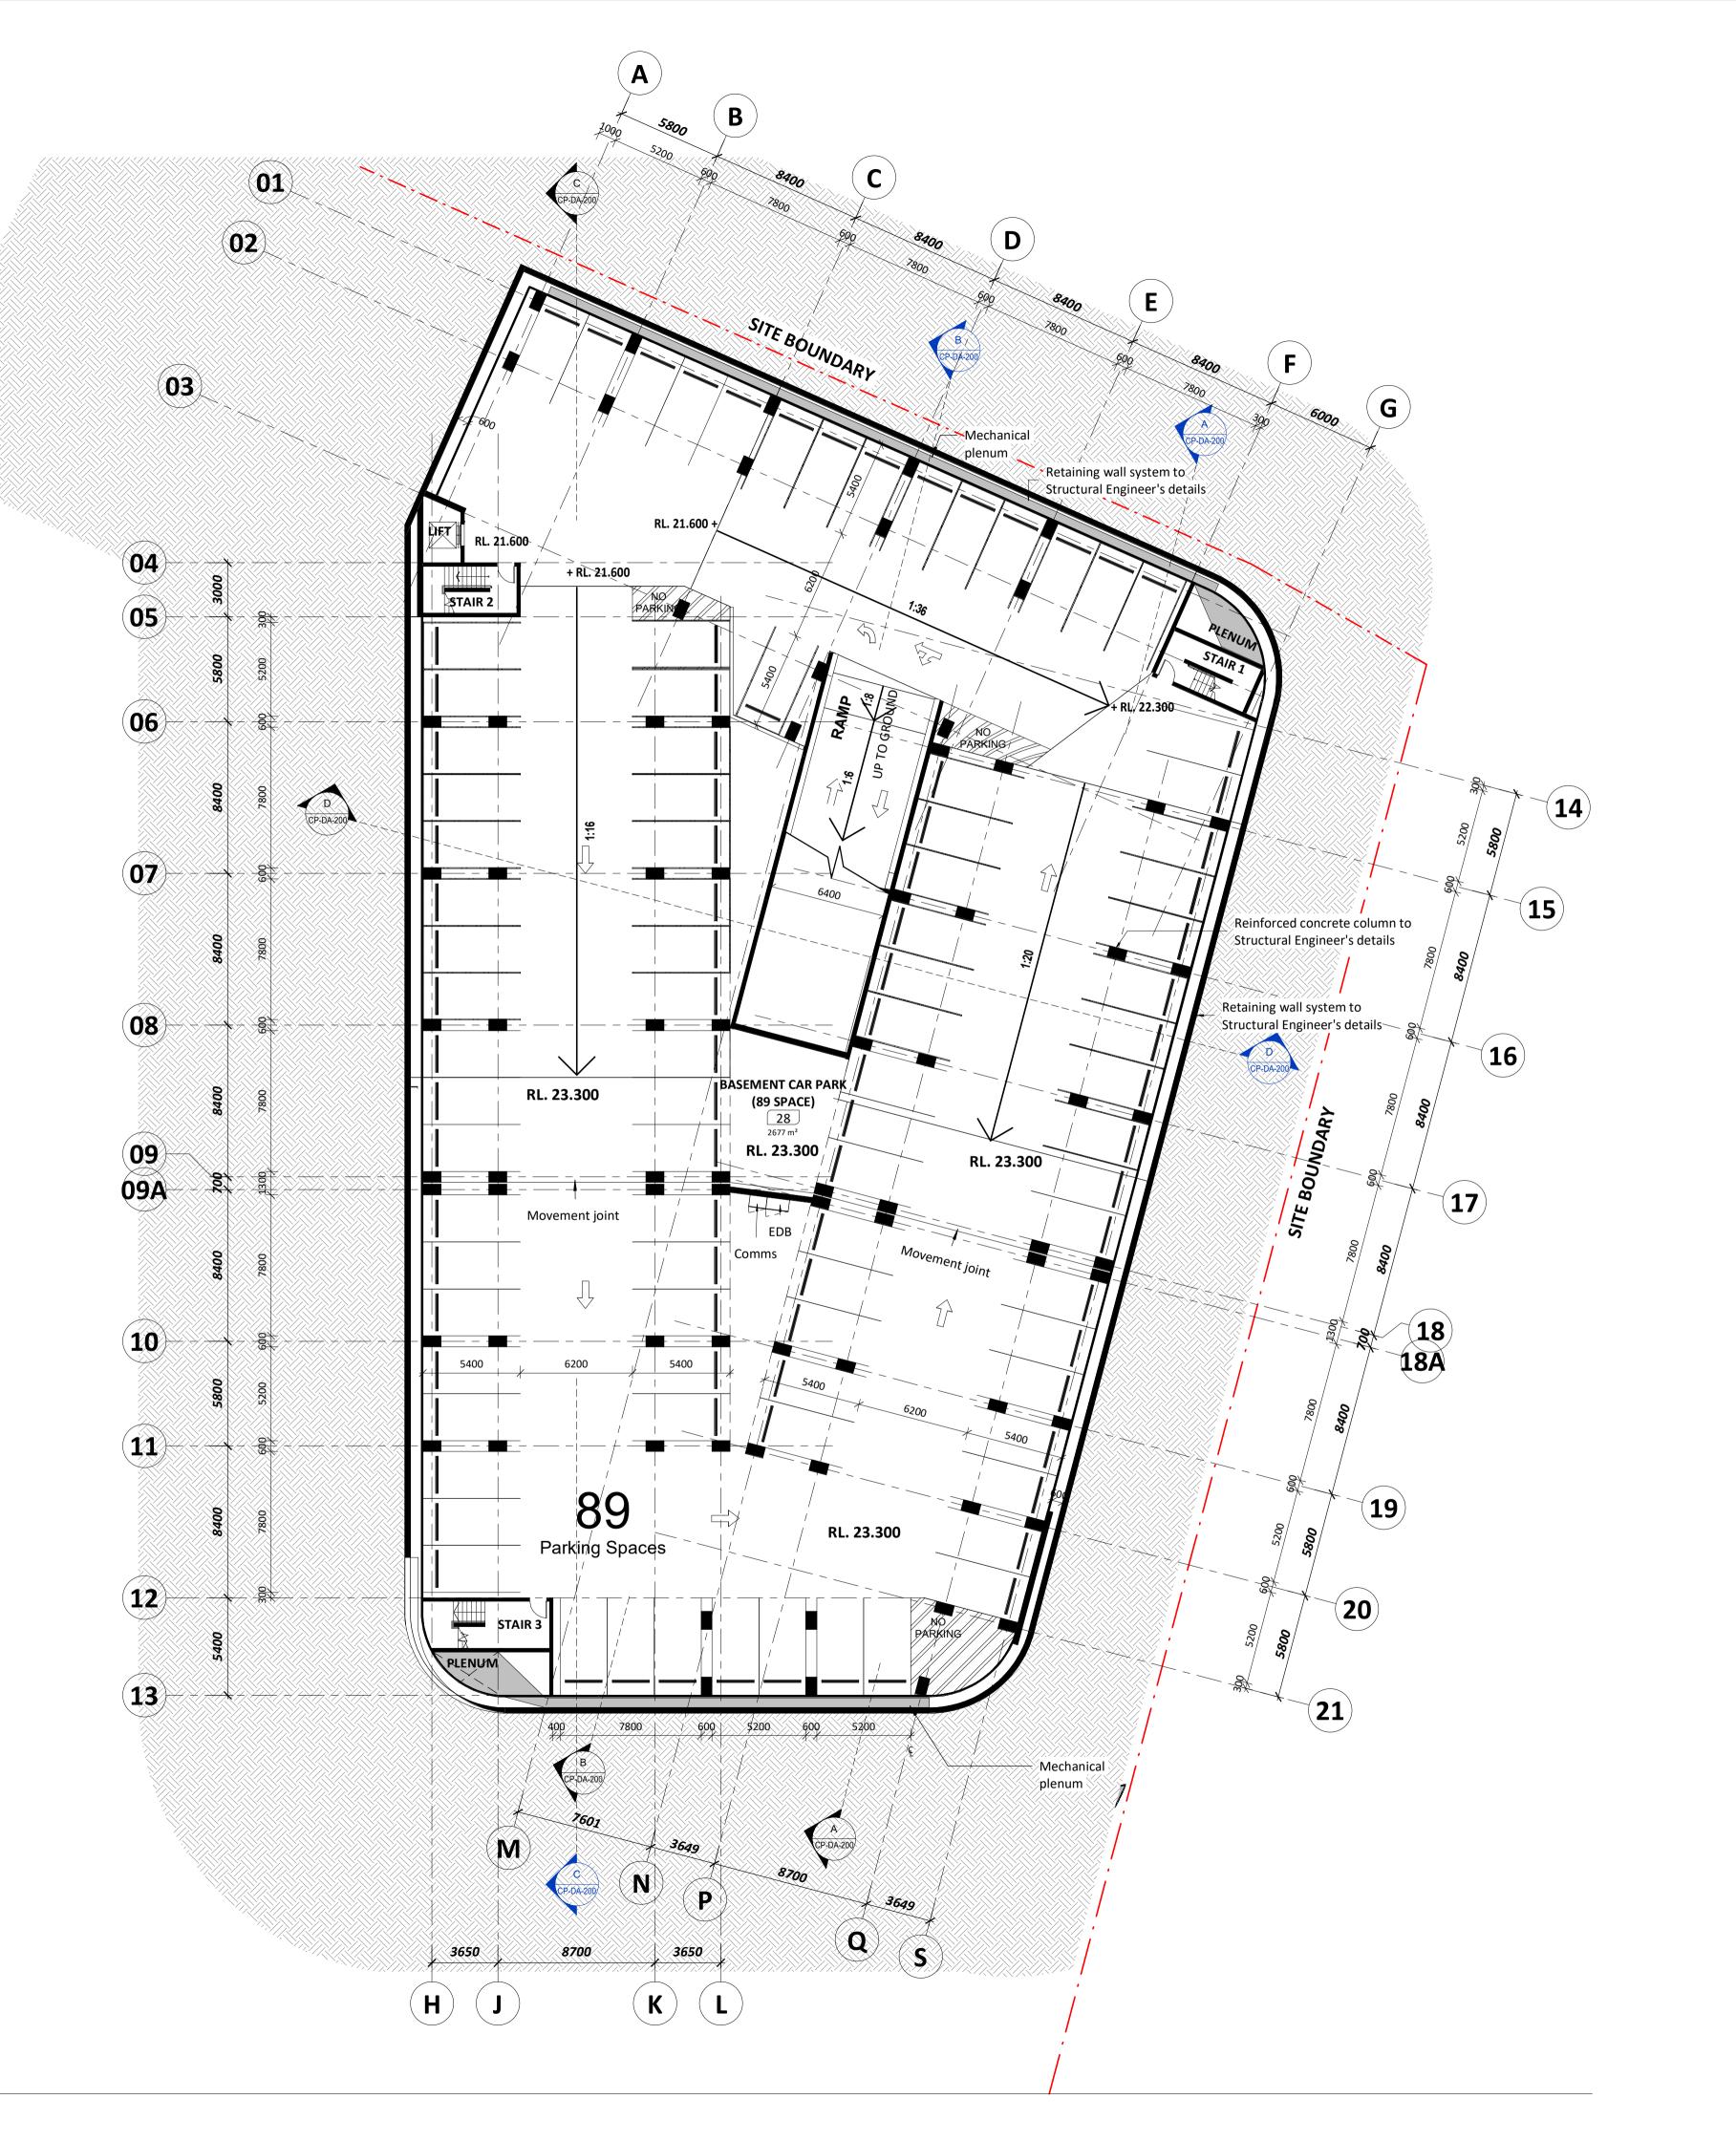

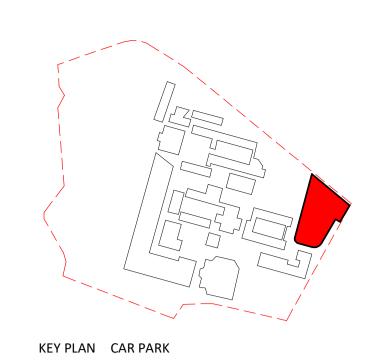

DEVELOPMENT APPLICATION SUBMISSION LB 31.03.2020 A subject p.a date issue


A R C H I T E C T U R

Westmead Catholic Community

Darcy Road, Westmead

Catholic Education Diocese of Parramatta


DEVELOPMENT APPLICATION

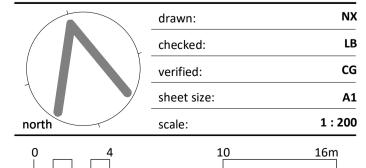

PROPOSED BASEMENT PLAN

19122 CP-DA-100 A sheet_no.



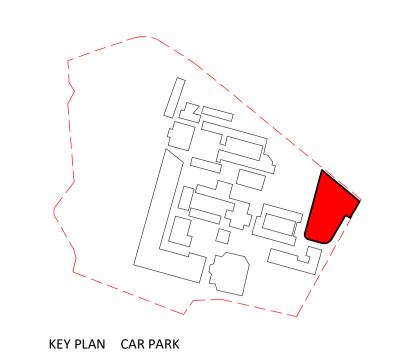

REVISED DEVELOPMENT APPLICATION LB 16.07.2020 B
SUBMISSION LB 31.03.2020 A
Subject p.a date issue
architect


A R C H I T E C T U R E

Nominated Architect: Charles Glanville, NSW Registration No. 313

Westmead Catholic Community

Darcy Road, Westmead


Catholic Education Diocese of Parramatta

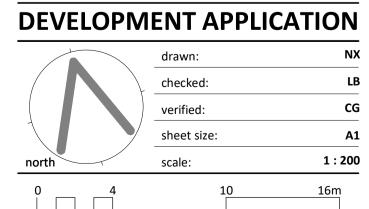


PROPOSED GROUND FLOOR
PLAN - PART 1
sheet

19122 CP-DA-101 B sheet_no. issue



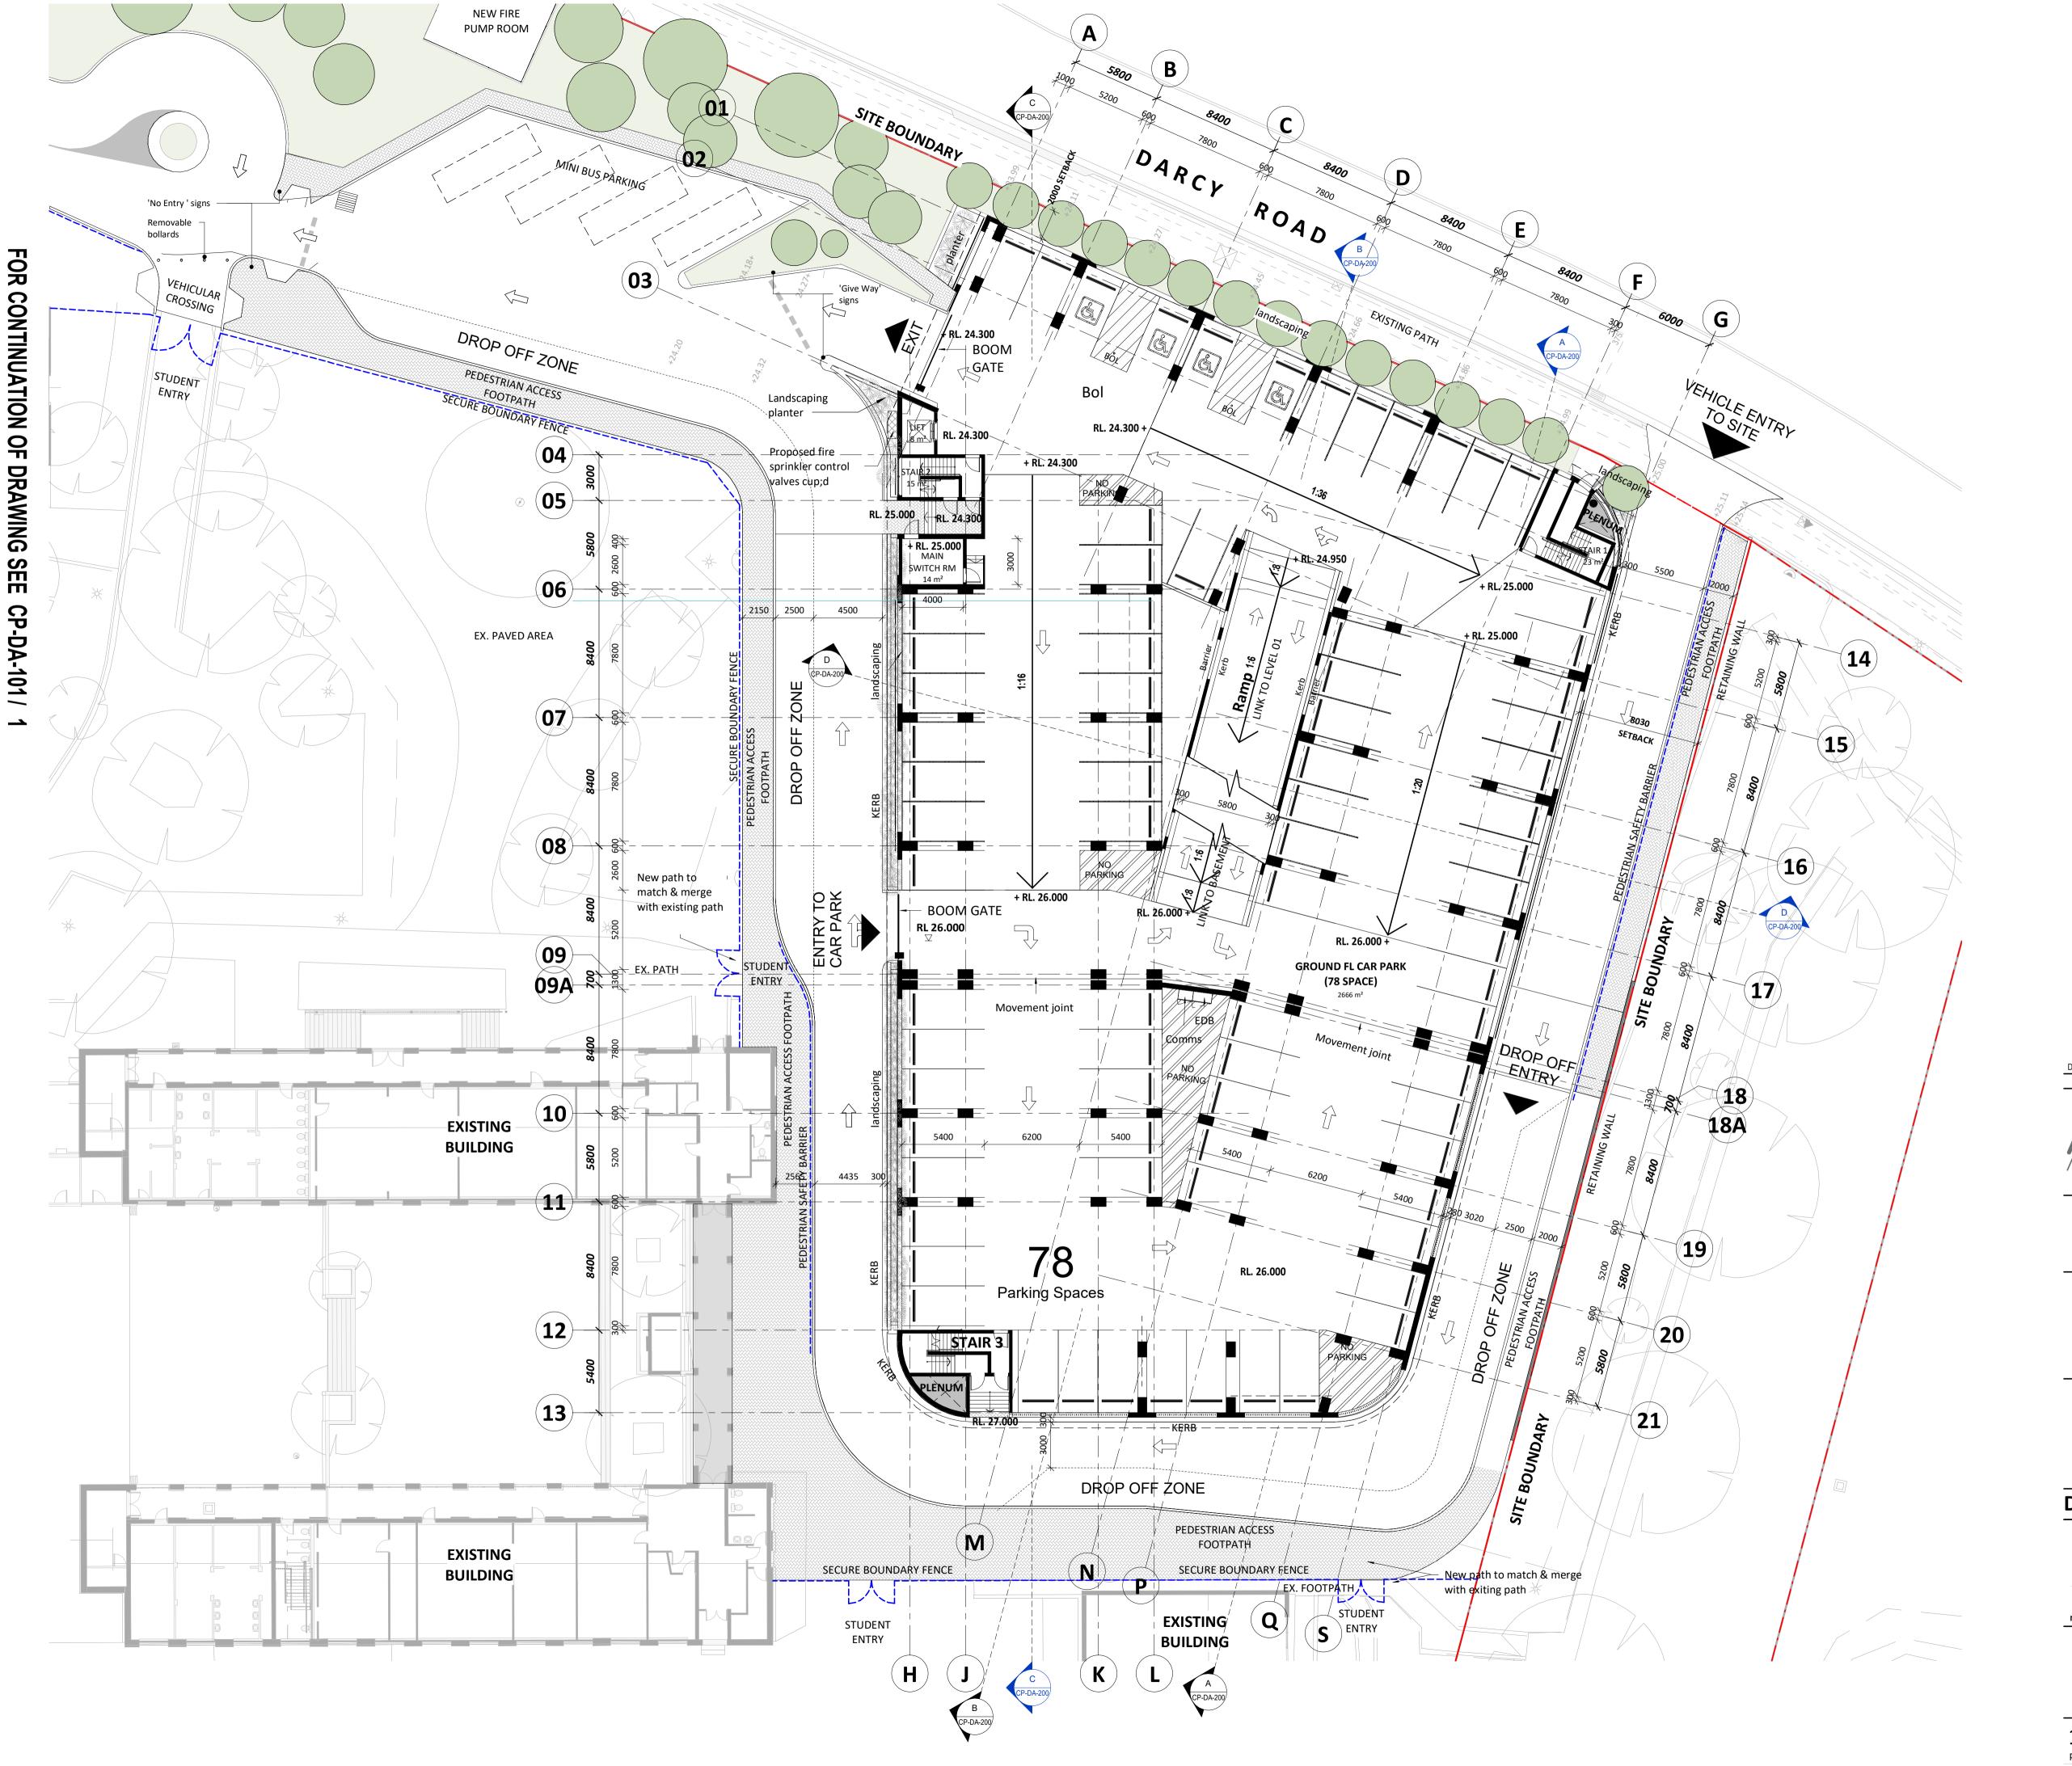

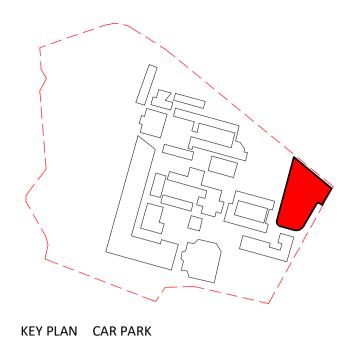


REVISED DEVELOPMENT APPLICATION LB 16.07.
SUBMISSION
DEVELOPMENT APPLICATION SUBMISSION LB 31.03.

ALLEANZA PCHETECTURE

Westmead Catholic Community

Darcy Road, Westmead


Catholic Education Diocese
of Parramatta

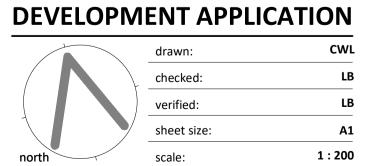


PROPOSED GROUND FLOOR

PLAN - PART 2

19122 CP-DA-102 sheet_no. is:

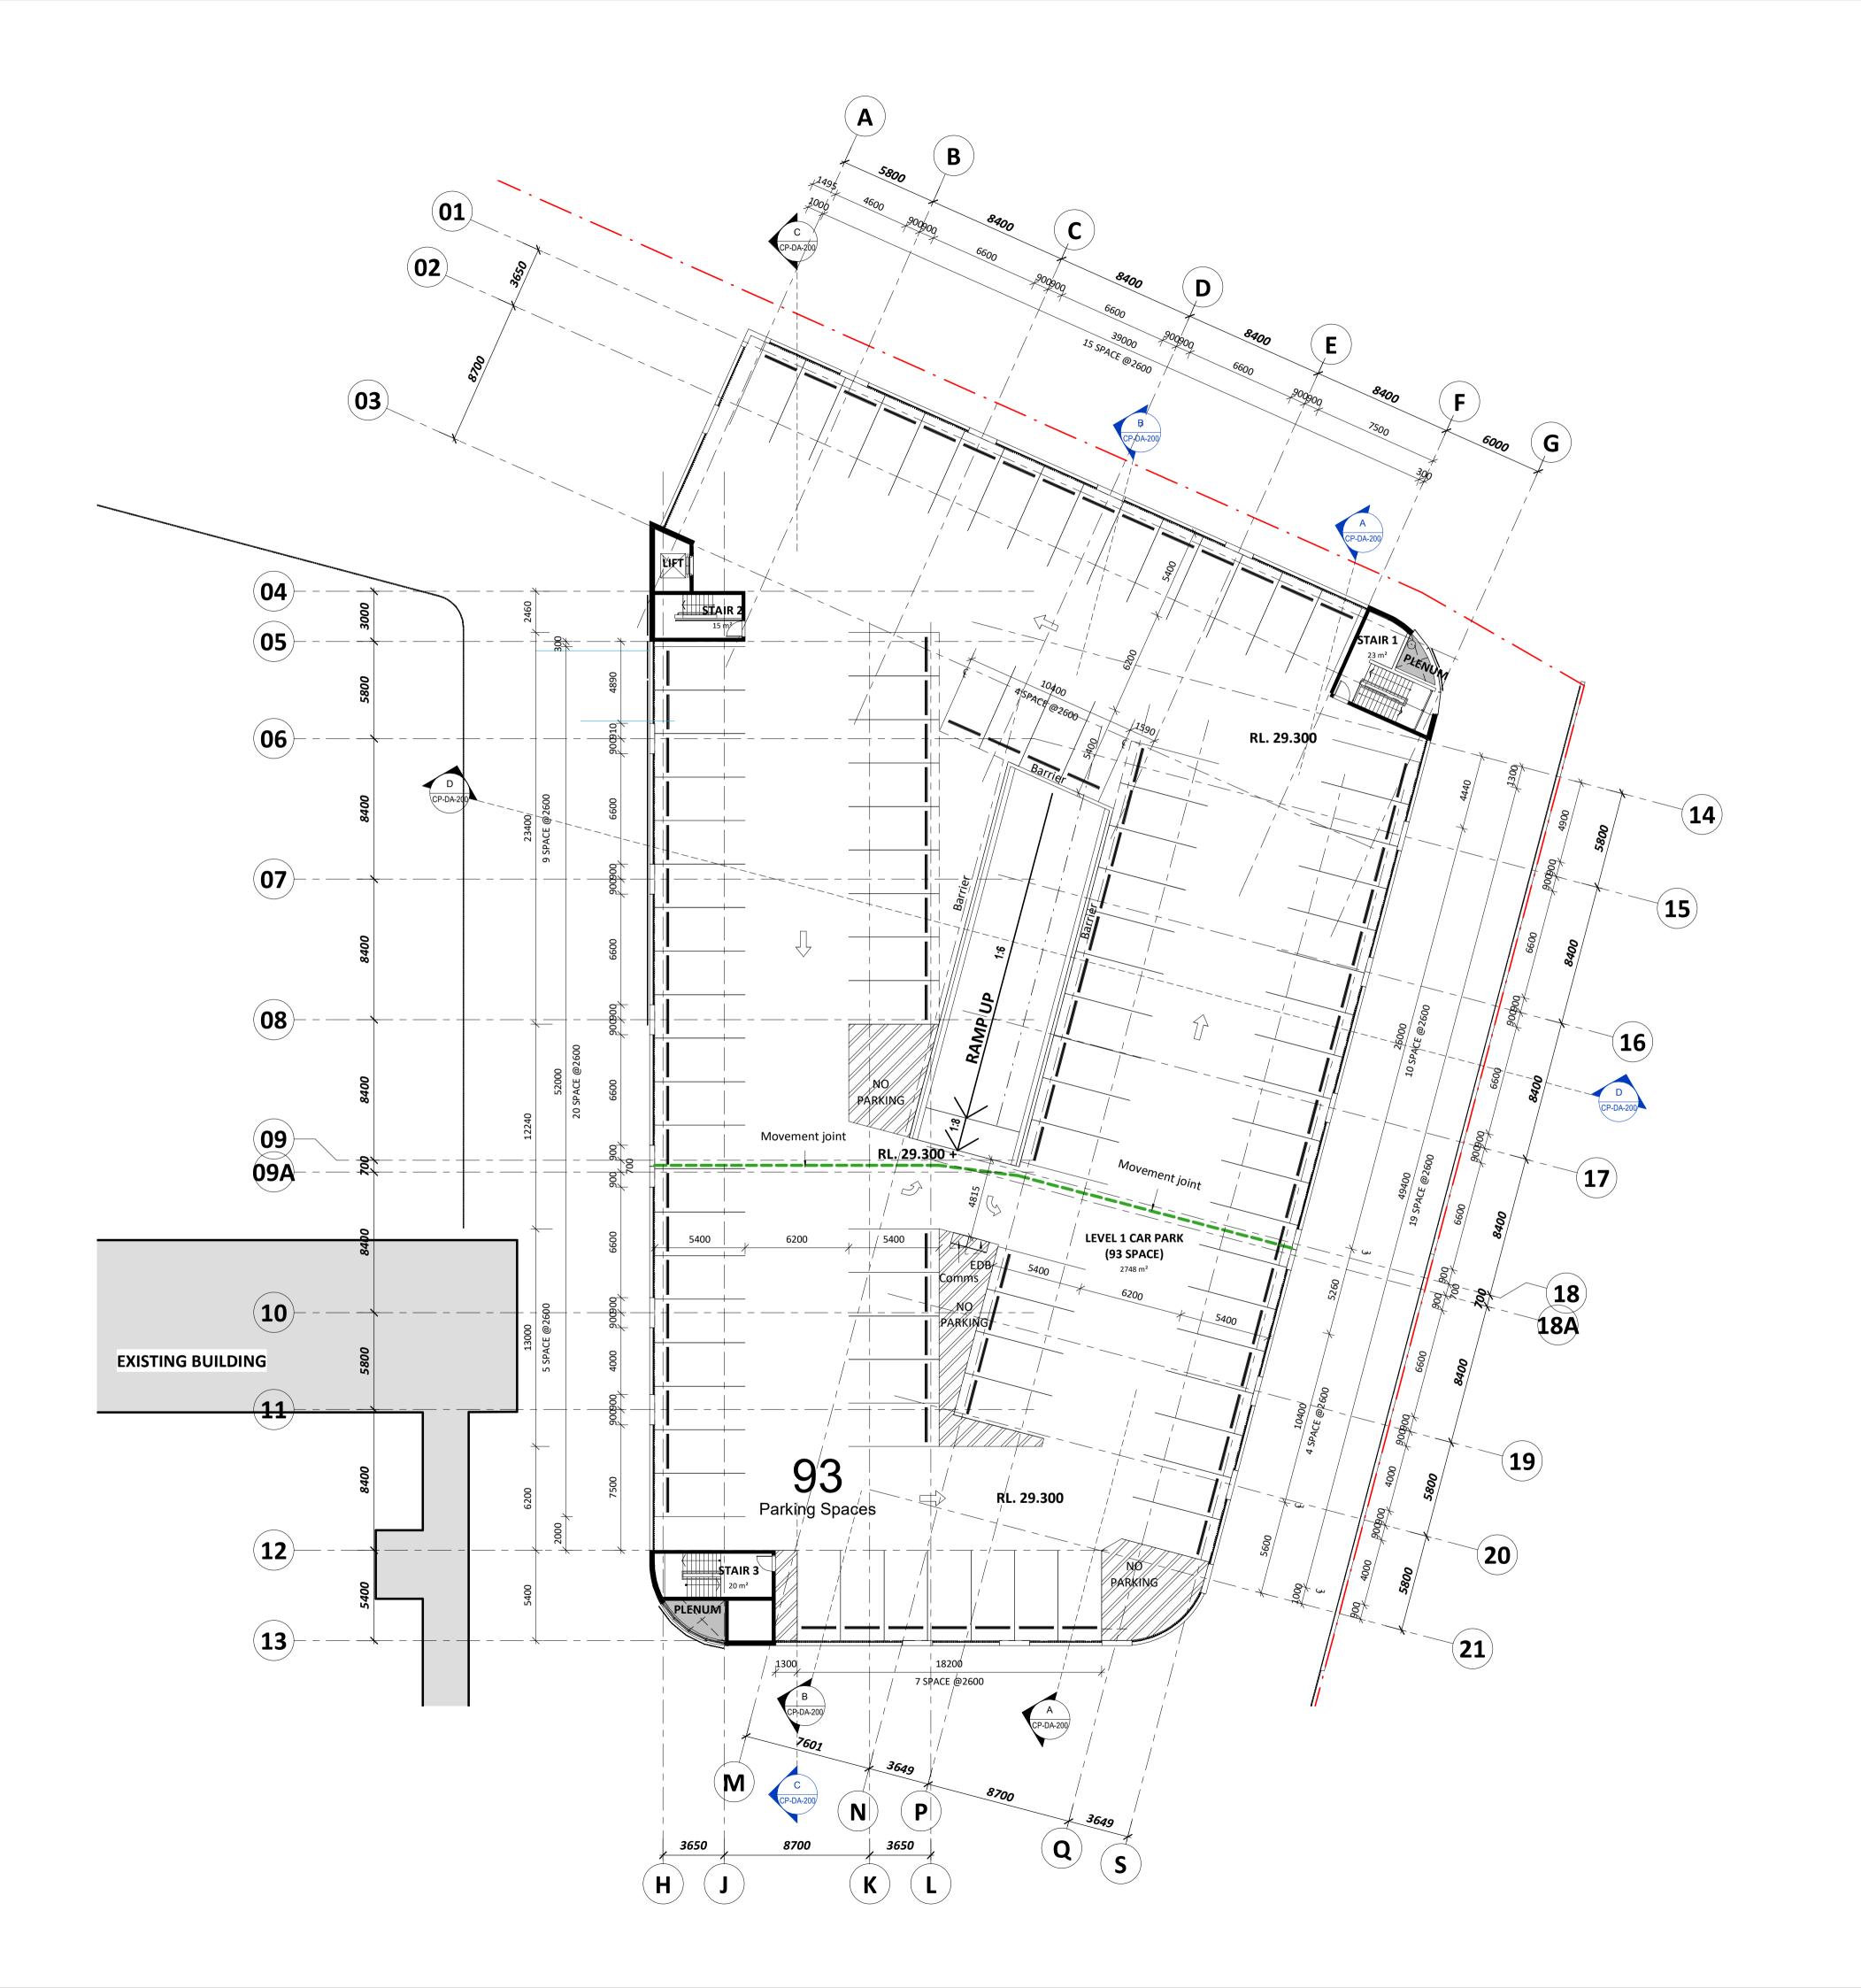

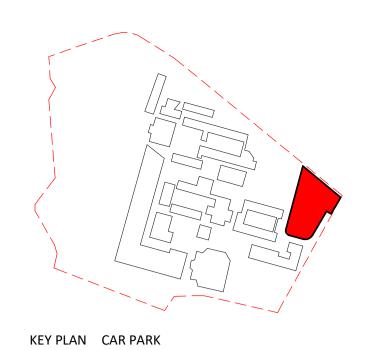


DEVELOPMENT APPLICATION SUBMISSION LB 31.03.2020 A subject p.a date issue

A R C H I T E C T U R

Westmead Catholic Community


Darcy Road, Westmead


Catholic Education Diocese of Parramatta

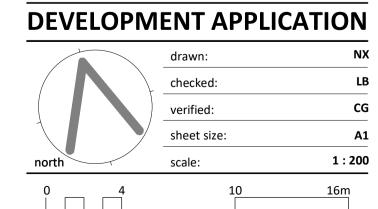



PROPOSED LEVEL 1 FLOOR
PLAN
sheet


19122 CP-DA-103 sheet_no.

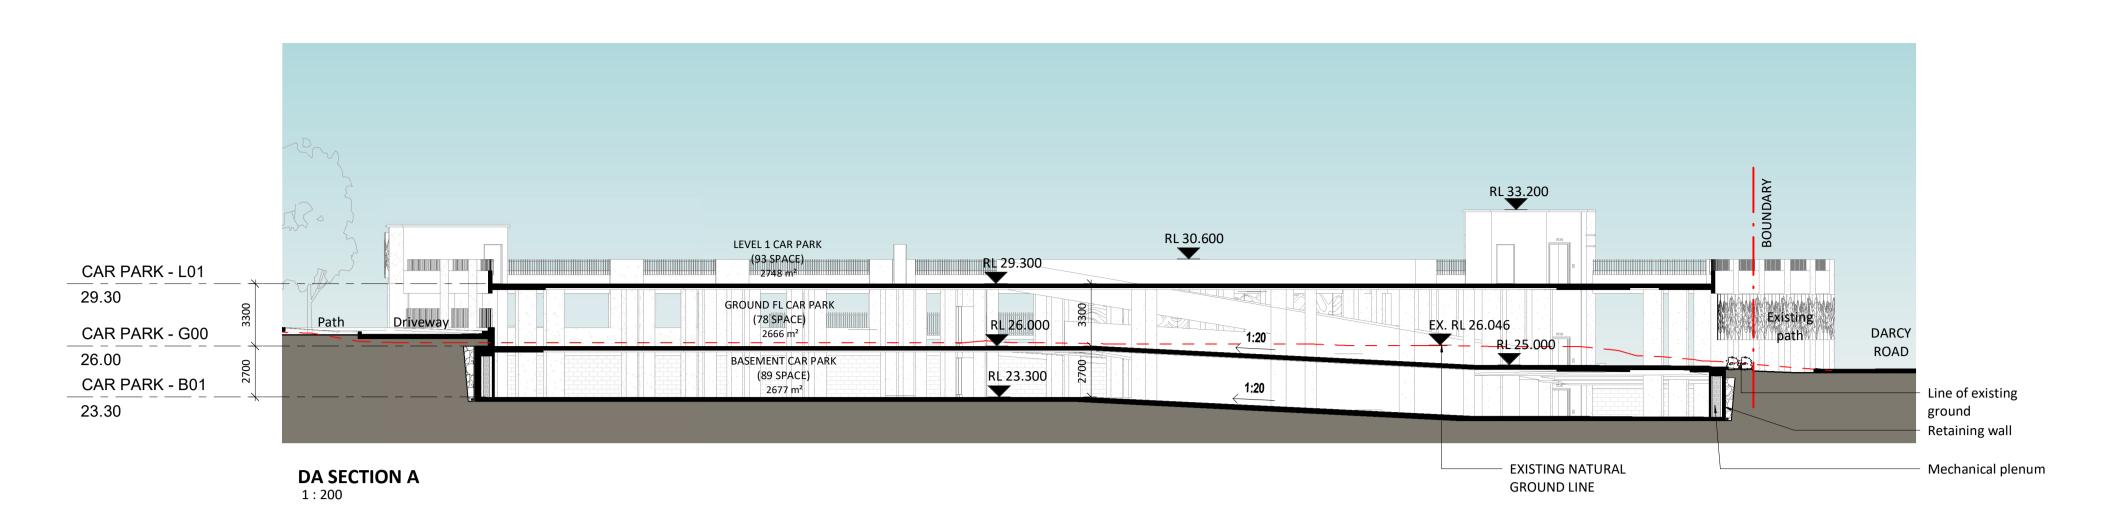

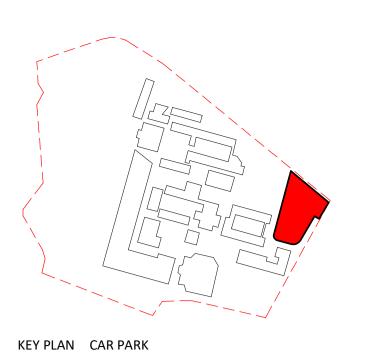

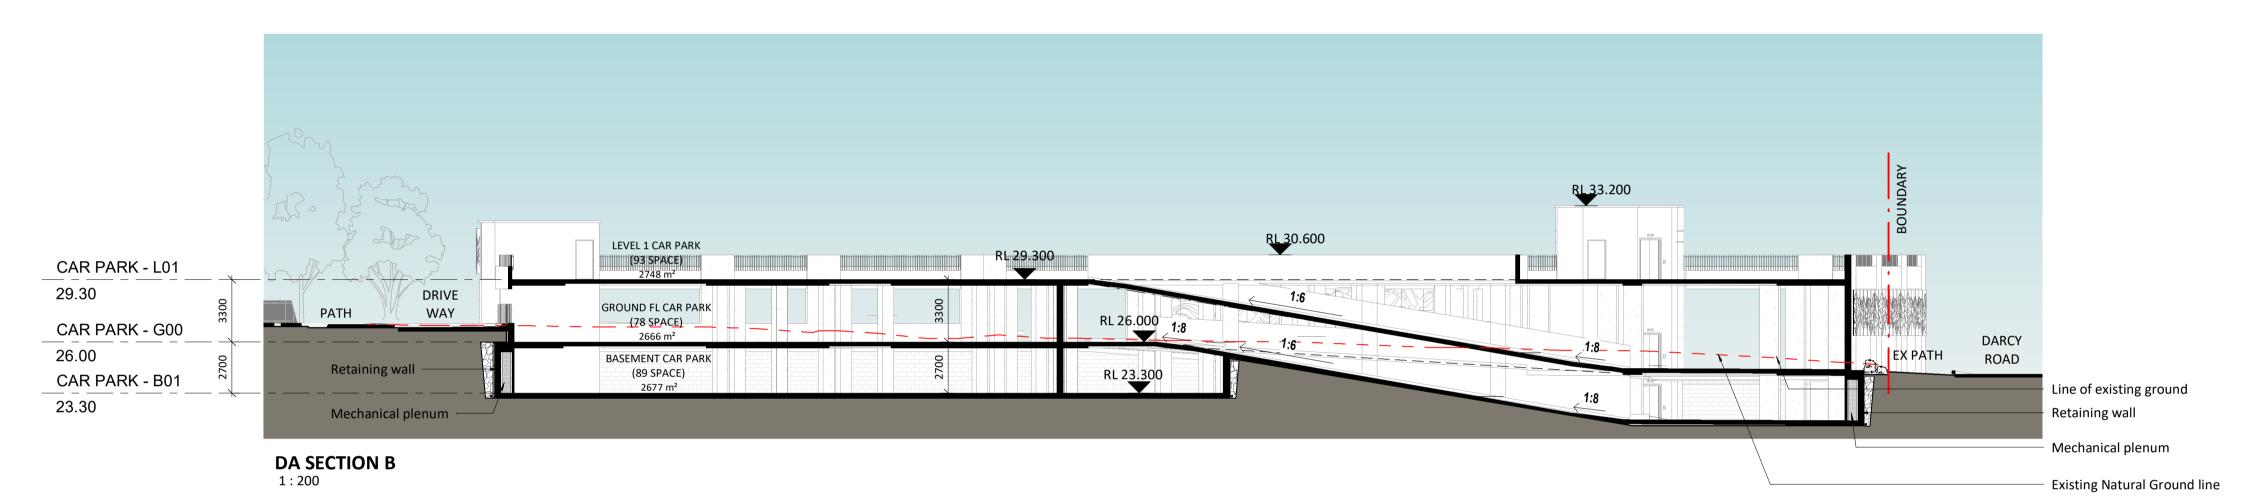

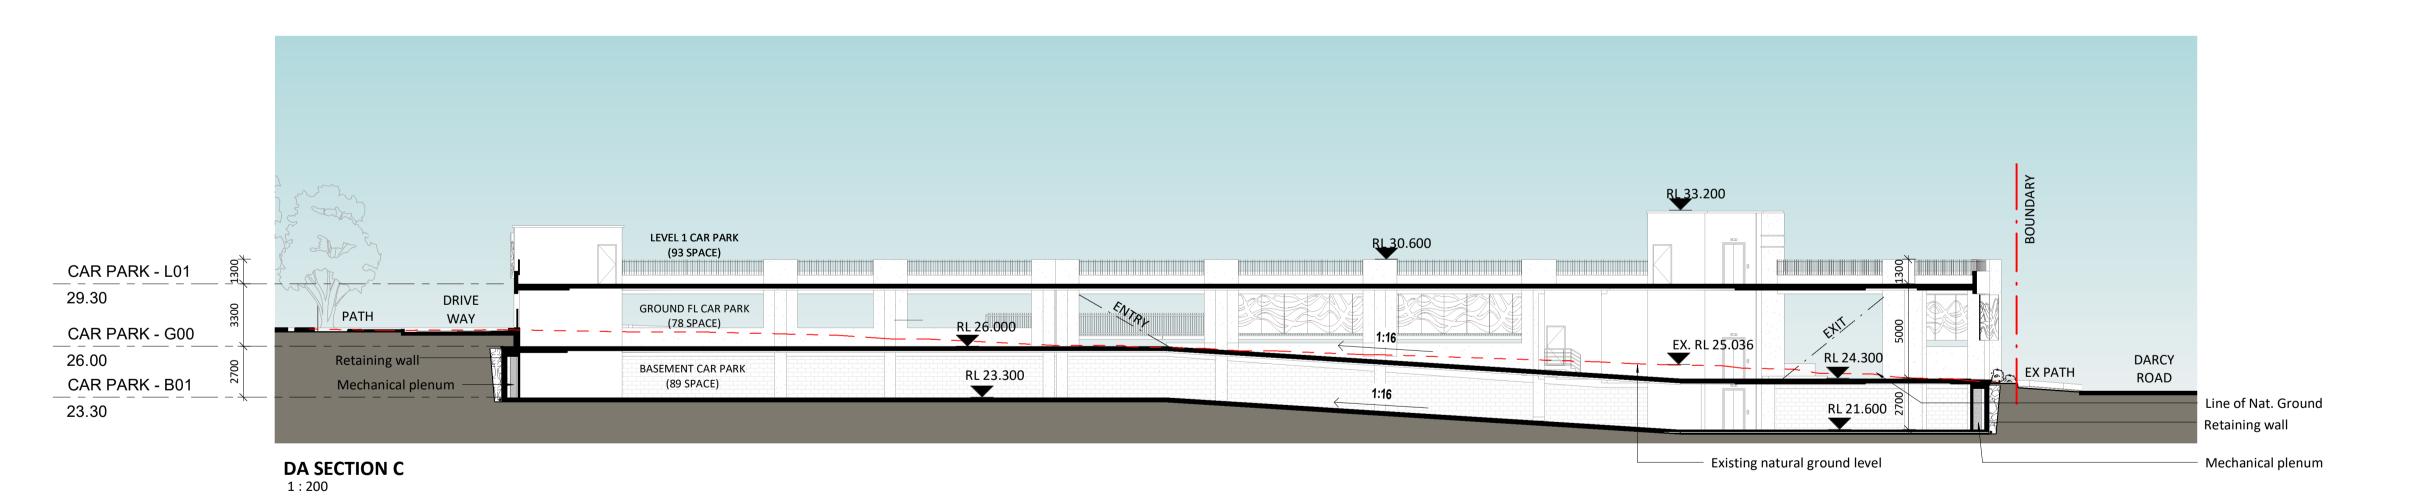

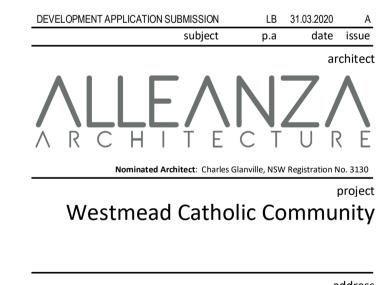



Catholic Education Diocese of Parramatta


Darcy Road, Westmead

	drawn:	N
	checked:	L
	verified:	С
	sheet size:	Δ
north	scale:	1:20
0 4	10	16m


	SECT	IONS
19122	CP-DA-200	A
project_no.	sheet no.	issu

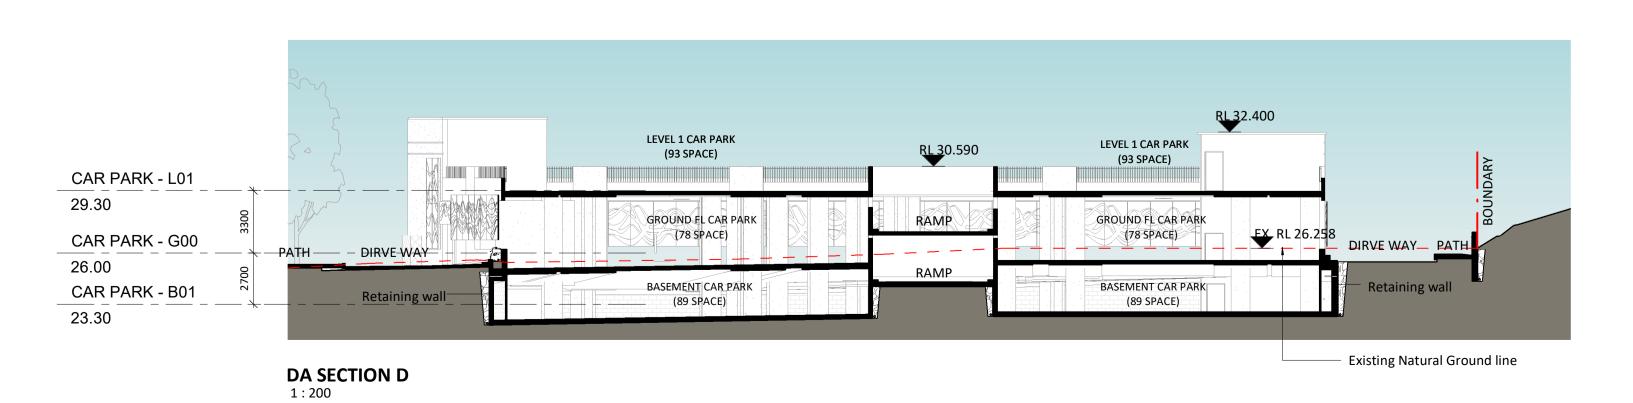

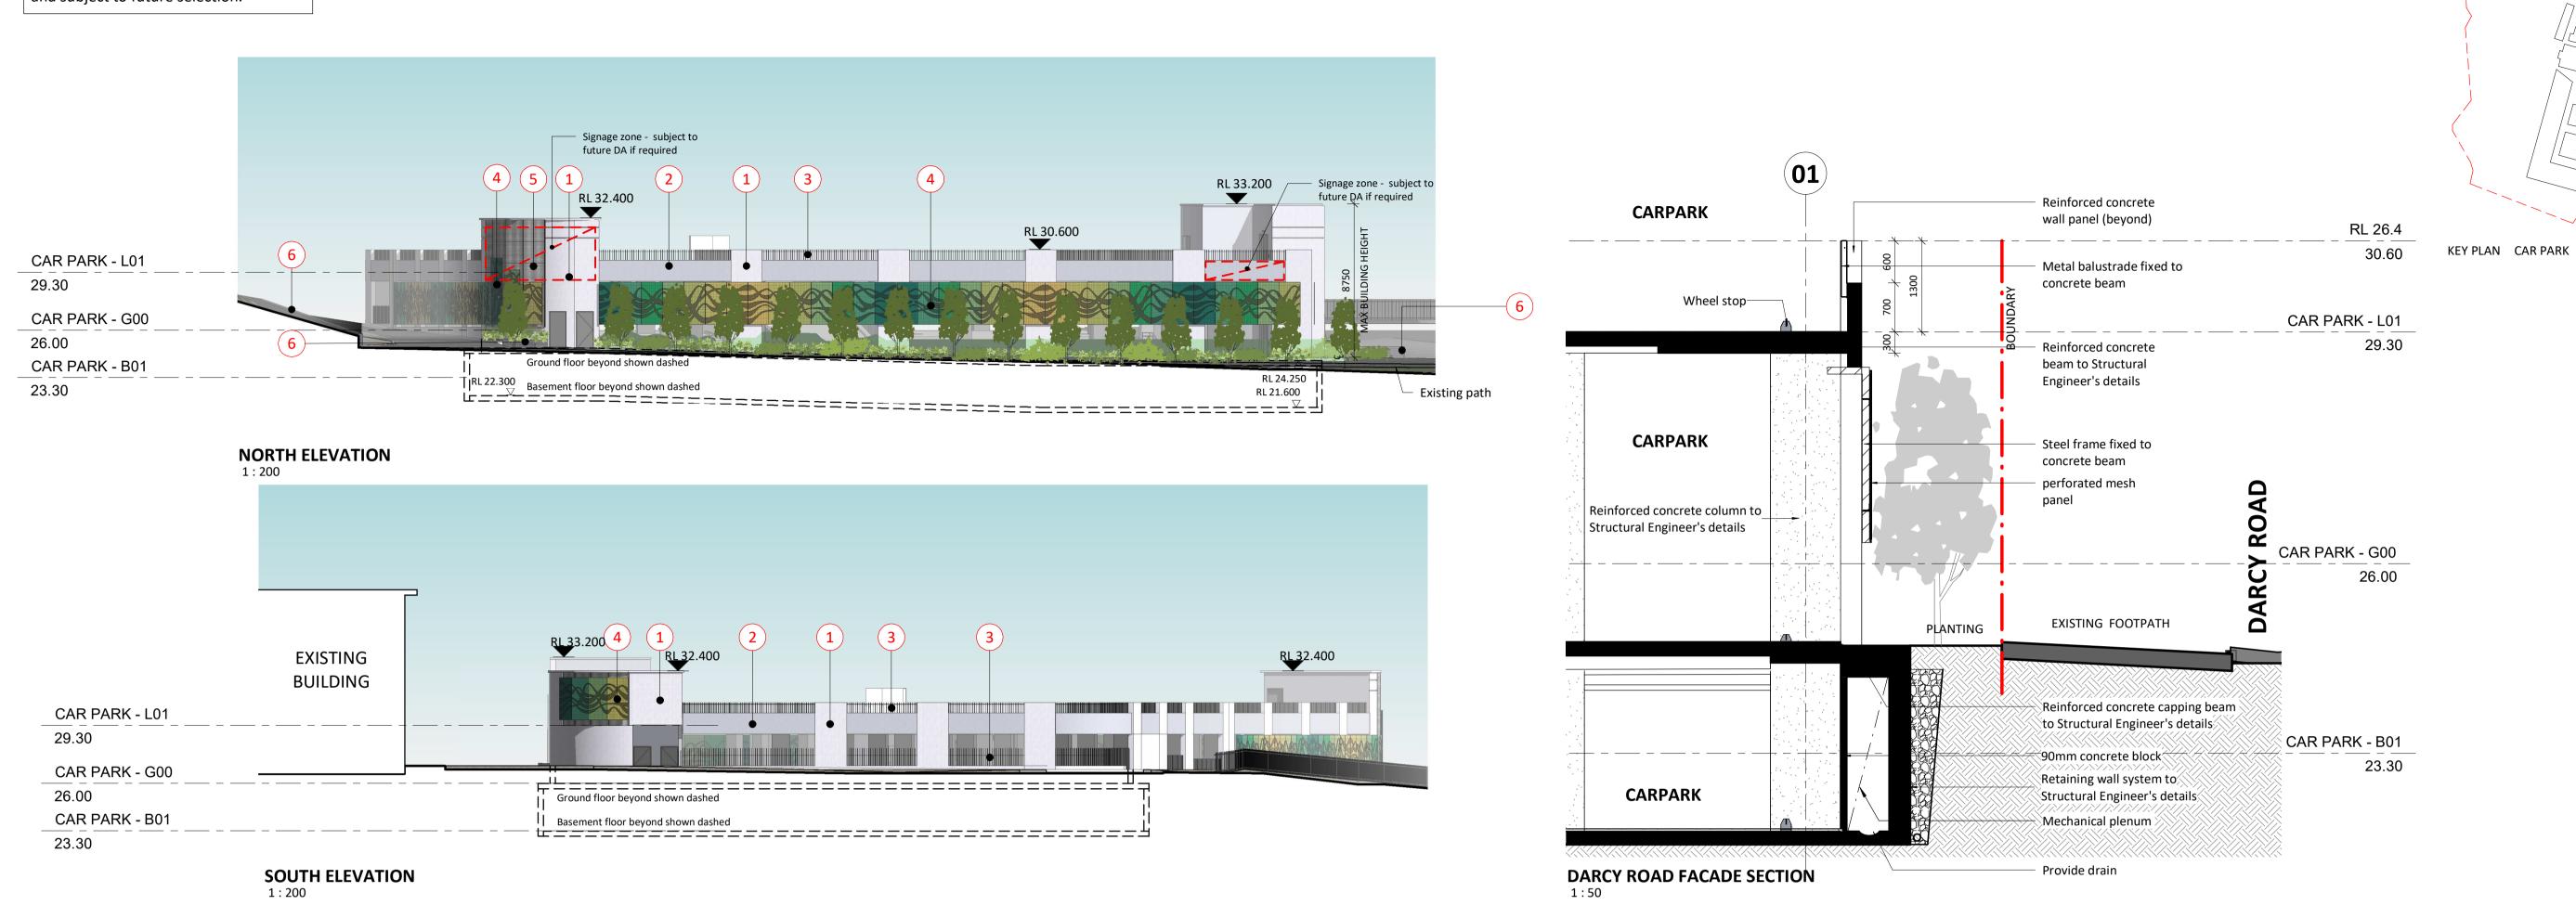

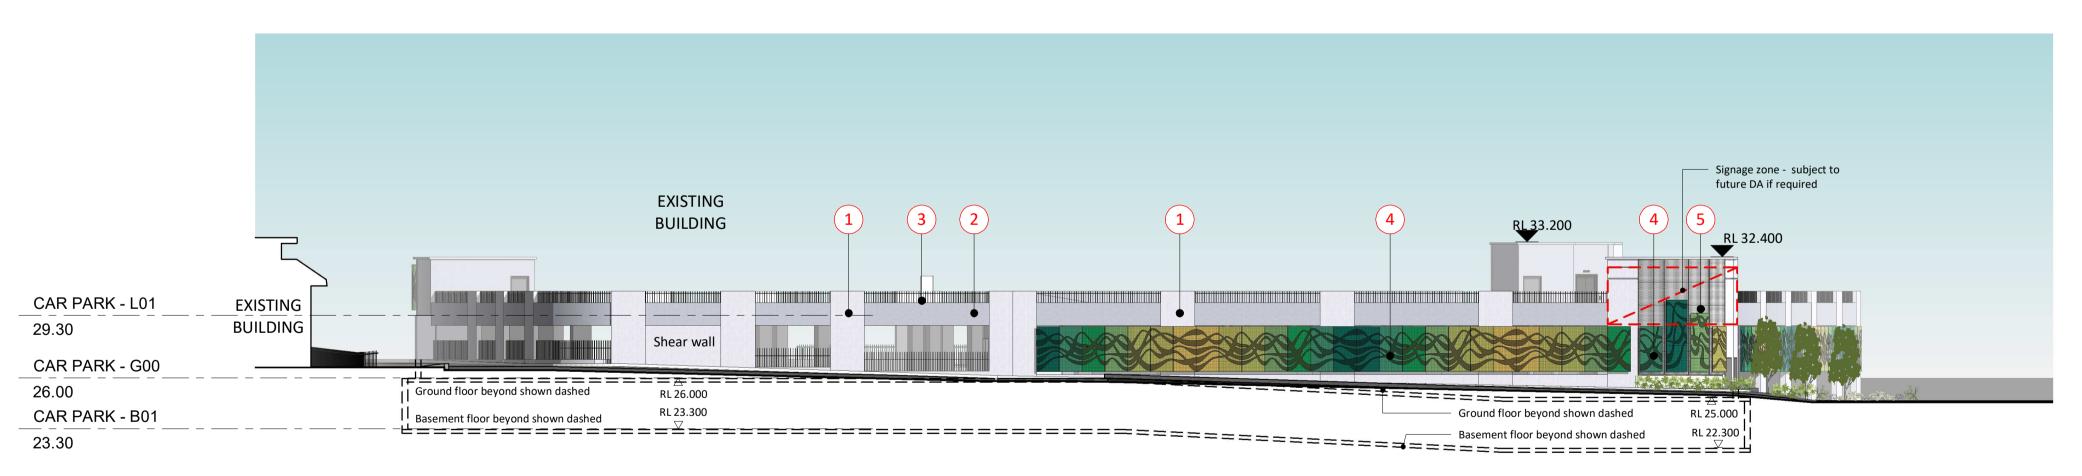



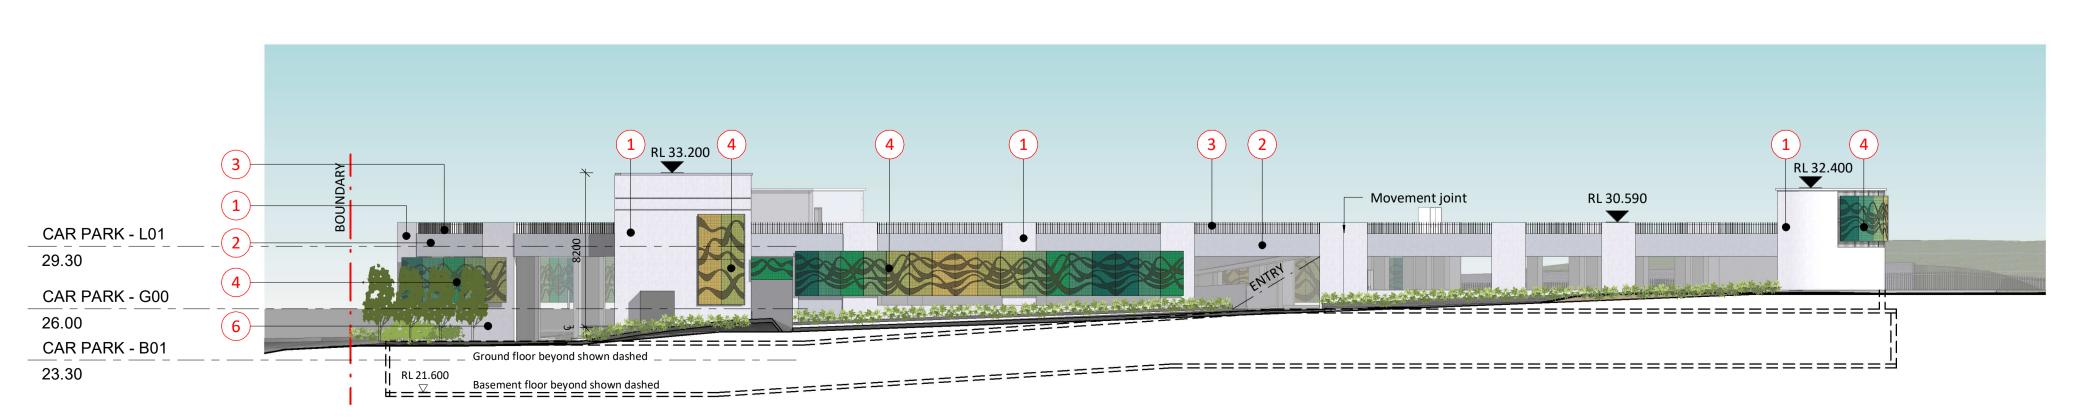

WEST ELEVATION

REVISED DEVELOPMENT APPLICATION LB 17.07.2020 B SUBMISSION DEVELOPMENT APPLICATION SUBMISSION p.a date issue

> Nominated Architect: Charles Glanville, NSW Registration No. 3130 Westmead Catholic Community

> > Darcy Road, Westmead

Catholic Education Diocese of Parramatta


	drawn:	NX
	checked:	LB
	verified:	CG
	sheet size:	A1
north	scale:	As indicated
04	10	16m

19122 CP-DA-210 project_no.


ELEVATIONS

1:200

and subject to future selection.

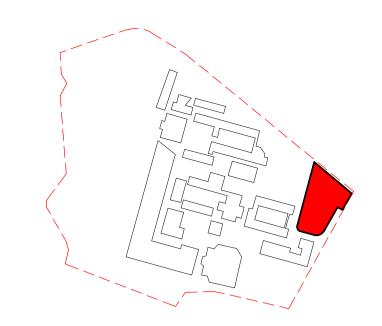


KEY PLAN CAR PARK

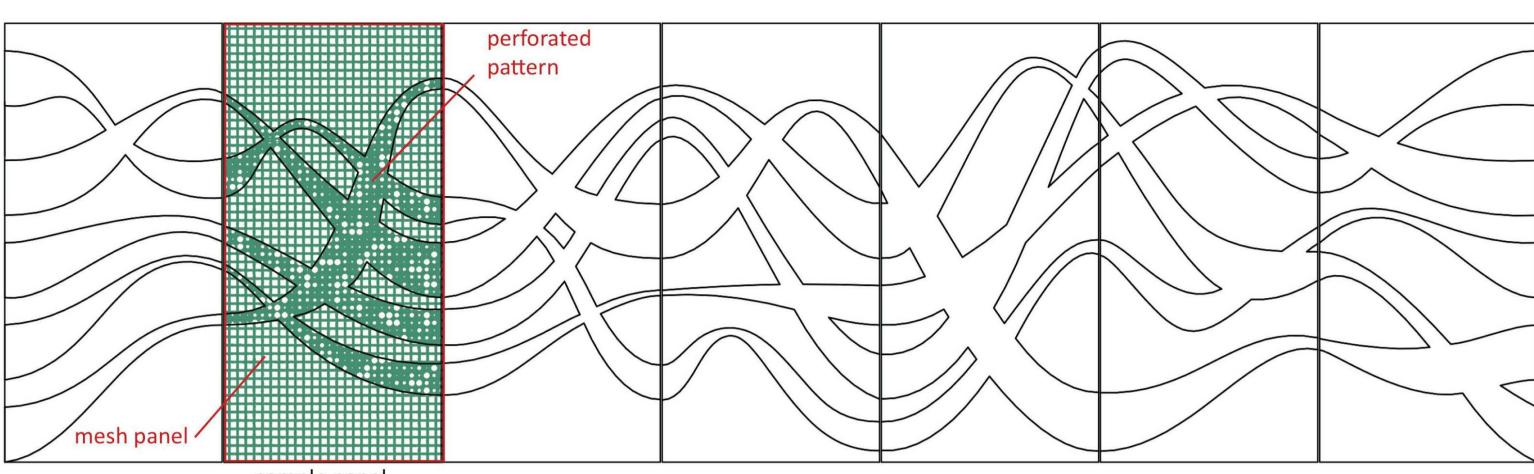



Powdercoated metal mesh screen

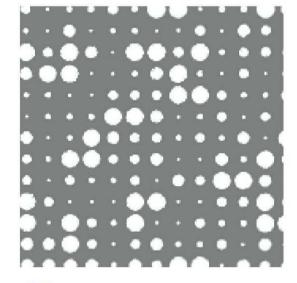

Powdercoated perforated metal screen (pattern: Champagne)



4 & 5 Powdercoat colour selection(Dulux Colours)



Painted Concrete
(C4- Colorbond-Shale Grey)



Painted Concrete
(C30- Colorbond- Basalt)



Face brick planter Austral(Blue Gum)

MATERIALS LEGEND

1. Painted ConcreteC4 - Colorbond 'Shale Grey' or similar

2. Painted ConcreteC30 - Colorbond 'Basalt' or similar

3. Painted metal balustradeColorbond Monument or similar

4. Powerdercoated metal mesh screen- Colorbond Monument or similar

5. Powdercoated perforated metal screen- Refer to Finishes Board for paint colours

6. Face brick planter- Austral 'Blue Gum' or similar

Nominated Architect: Charles Glanville, NSW Registration No. 3130

project

Westmead Catholic Community

REVISED DEVELOPMENT APPLICATION SUBMISSION DEVELOPMENT APPLICATION SUBMISSION

Darcy Road, Westmead

Catholic Education Diocese of Parramatta

DEVELOPMENT APPLICATIONdrawn:FBchecked:LBverified:LB


sheet size:


scale:

FINISHES
shee

1:200

19122 CP-DA-220 B sheet_no. issue

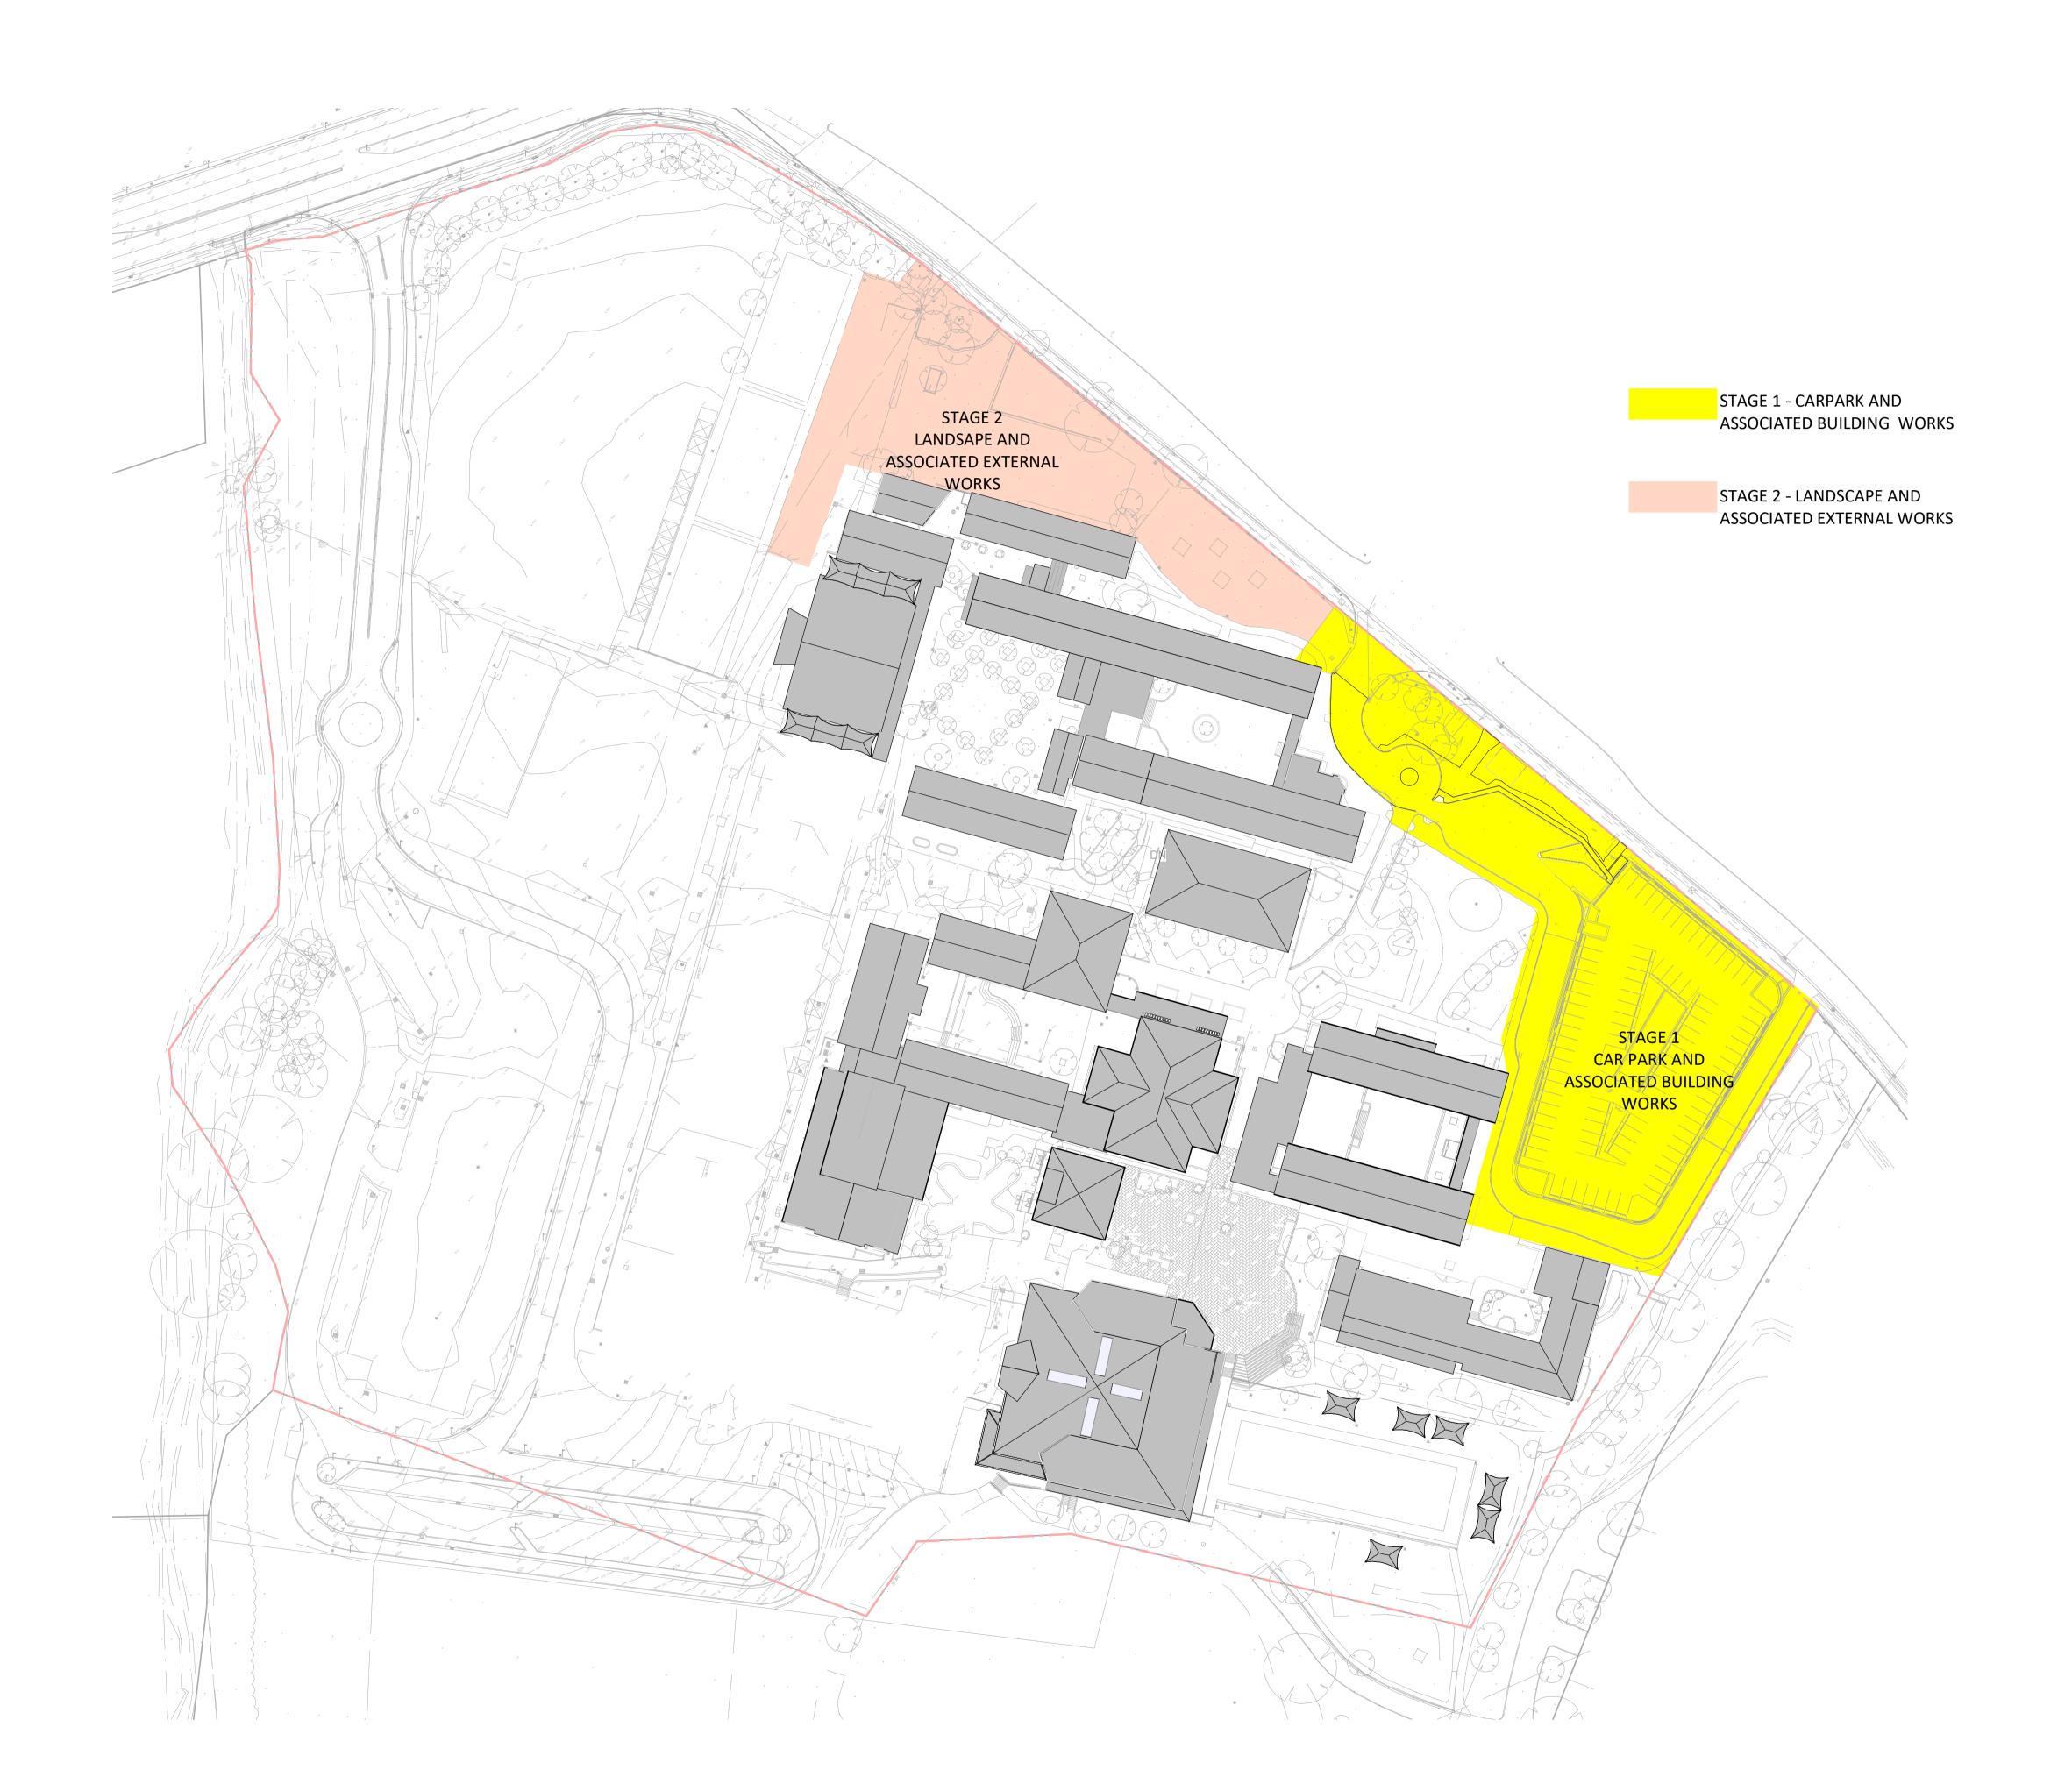

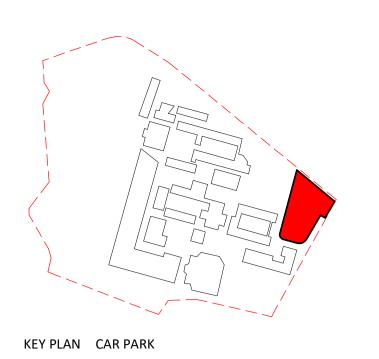

DEVELOPMENT APPLICATION SUBMISSION LB 31.03.2020 A
subject p.a date issue
architect


ARCHITECTURE

Westmead Catholic Community

Darcy Road, Westmead

Catholic Education Diocese of Parramatta

DEVELOPMENT APPLICATION

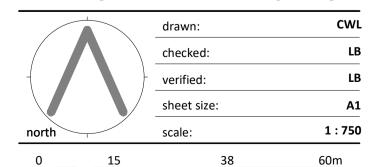

STAGING DIAGRAM sheet

19122 CP-DA-801 A sheet_no.

WESTMEAD CATHOLIC COMMUNITY

Westmead NSW 2145

CARPARK DA LANDSCAPE DOCUMENTATION

DOCUMENT REGISTER

DRAWING NUMBER	DRAWING NAME	SCALE / DRAWING SIZE
LA-001	LANDSCAPE COVER SHEET	-
LA-101	LANDSCAPE MASTERPLAN	1:1000 / A1
LA-201	EXISTING TREE PLAN	1:500 / A1
LA-301	CARPARK LANDSCAPE PLAN	1:250 / A1
LA-401	CARPARK DEEP SOIL	1:750 / A1
LA-501	INDICATIVE PLANT PALETTE	1:20 / A1

FOR DEVELOPMENT APPLICATION

DATE JOB NUMBER DRAWN CHECKED

WESTMEAD CATHOLIC COMMUNITY

LA-001

REV

16-Jul-20 20190722 MC RL

WESTMEAD, NSW 2145

SCALE

N/A



© GROUND INK PTY LTD THIS DESIGN AND DRAWING IS PROTECTED BY COPYRIGHT.





https://www.alleanza.com.au/



https://winim.com.au/




SYDNEY, NSW 2000

https://northrop.com.au/

PH. (02) 9241 4188

VERIFY ALL DIMENSIONS ON SITE BEFORE COMMENCING WORK. REPORT ALL DISCREPANCIES TO LANDSCAPE ARCHITECT PRIOR TO CONSTRUCTION. FIGURED DIMENSIONS TO BE TAKEN IN PREFERENCE TO SCALED DRAWINGS. ALL WORK IS TO CONFORM TO RELEVANT AUSTRALIAN STANDARDS AND OTHER CODES AS APPLICABLE. LOCATION OF UNDERGROUND SERVICES TO BE PROVEN ON SITE AND PROTECTED IF NECESSARY PRIOR TO CONSTRUCTION. DIAL BEFORE YOU DIG.PLANT SPECIES AND QUANTITIES SHOWN ARE INDICATIVE ONLY AND ARE SUBJECT TO CHANGE BASED ON FUTURE PROJECT REQUIREMENTS.

REVISION	DATE	DESCRIPTION	DRAWN	CHECKED	DRAWING TITLE
А	03 APR 20	FOR DEVELOPMENT APPLICATION	MC	RL	
В	16 JUL 20	REVISED DEVELOPMENT APPLICATION	NS	RL	
					LANDSCADE COVED CLIEFT
					LANDSCAPE COVER SHEET

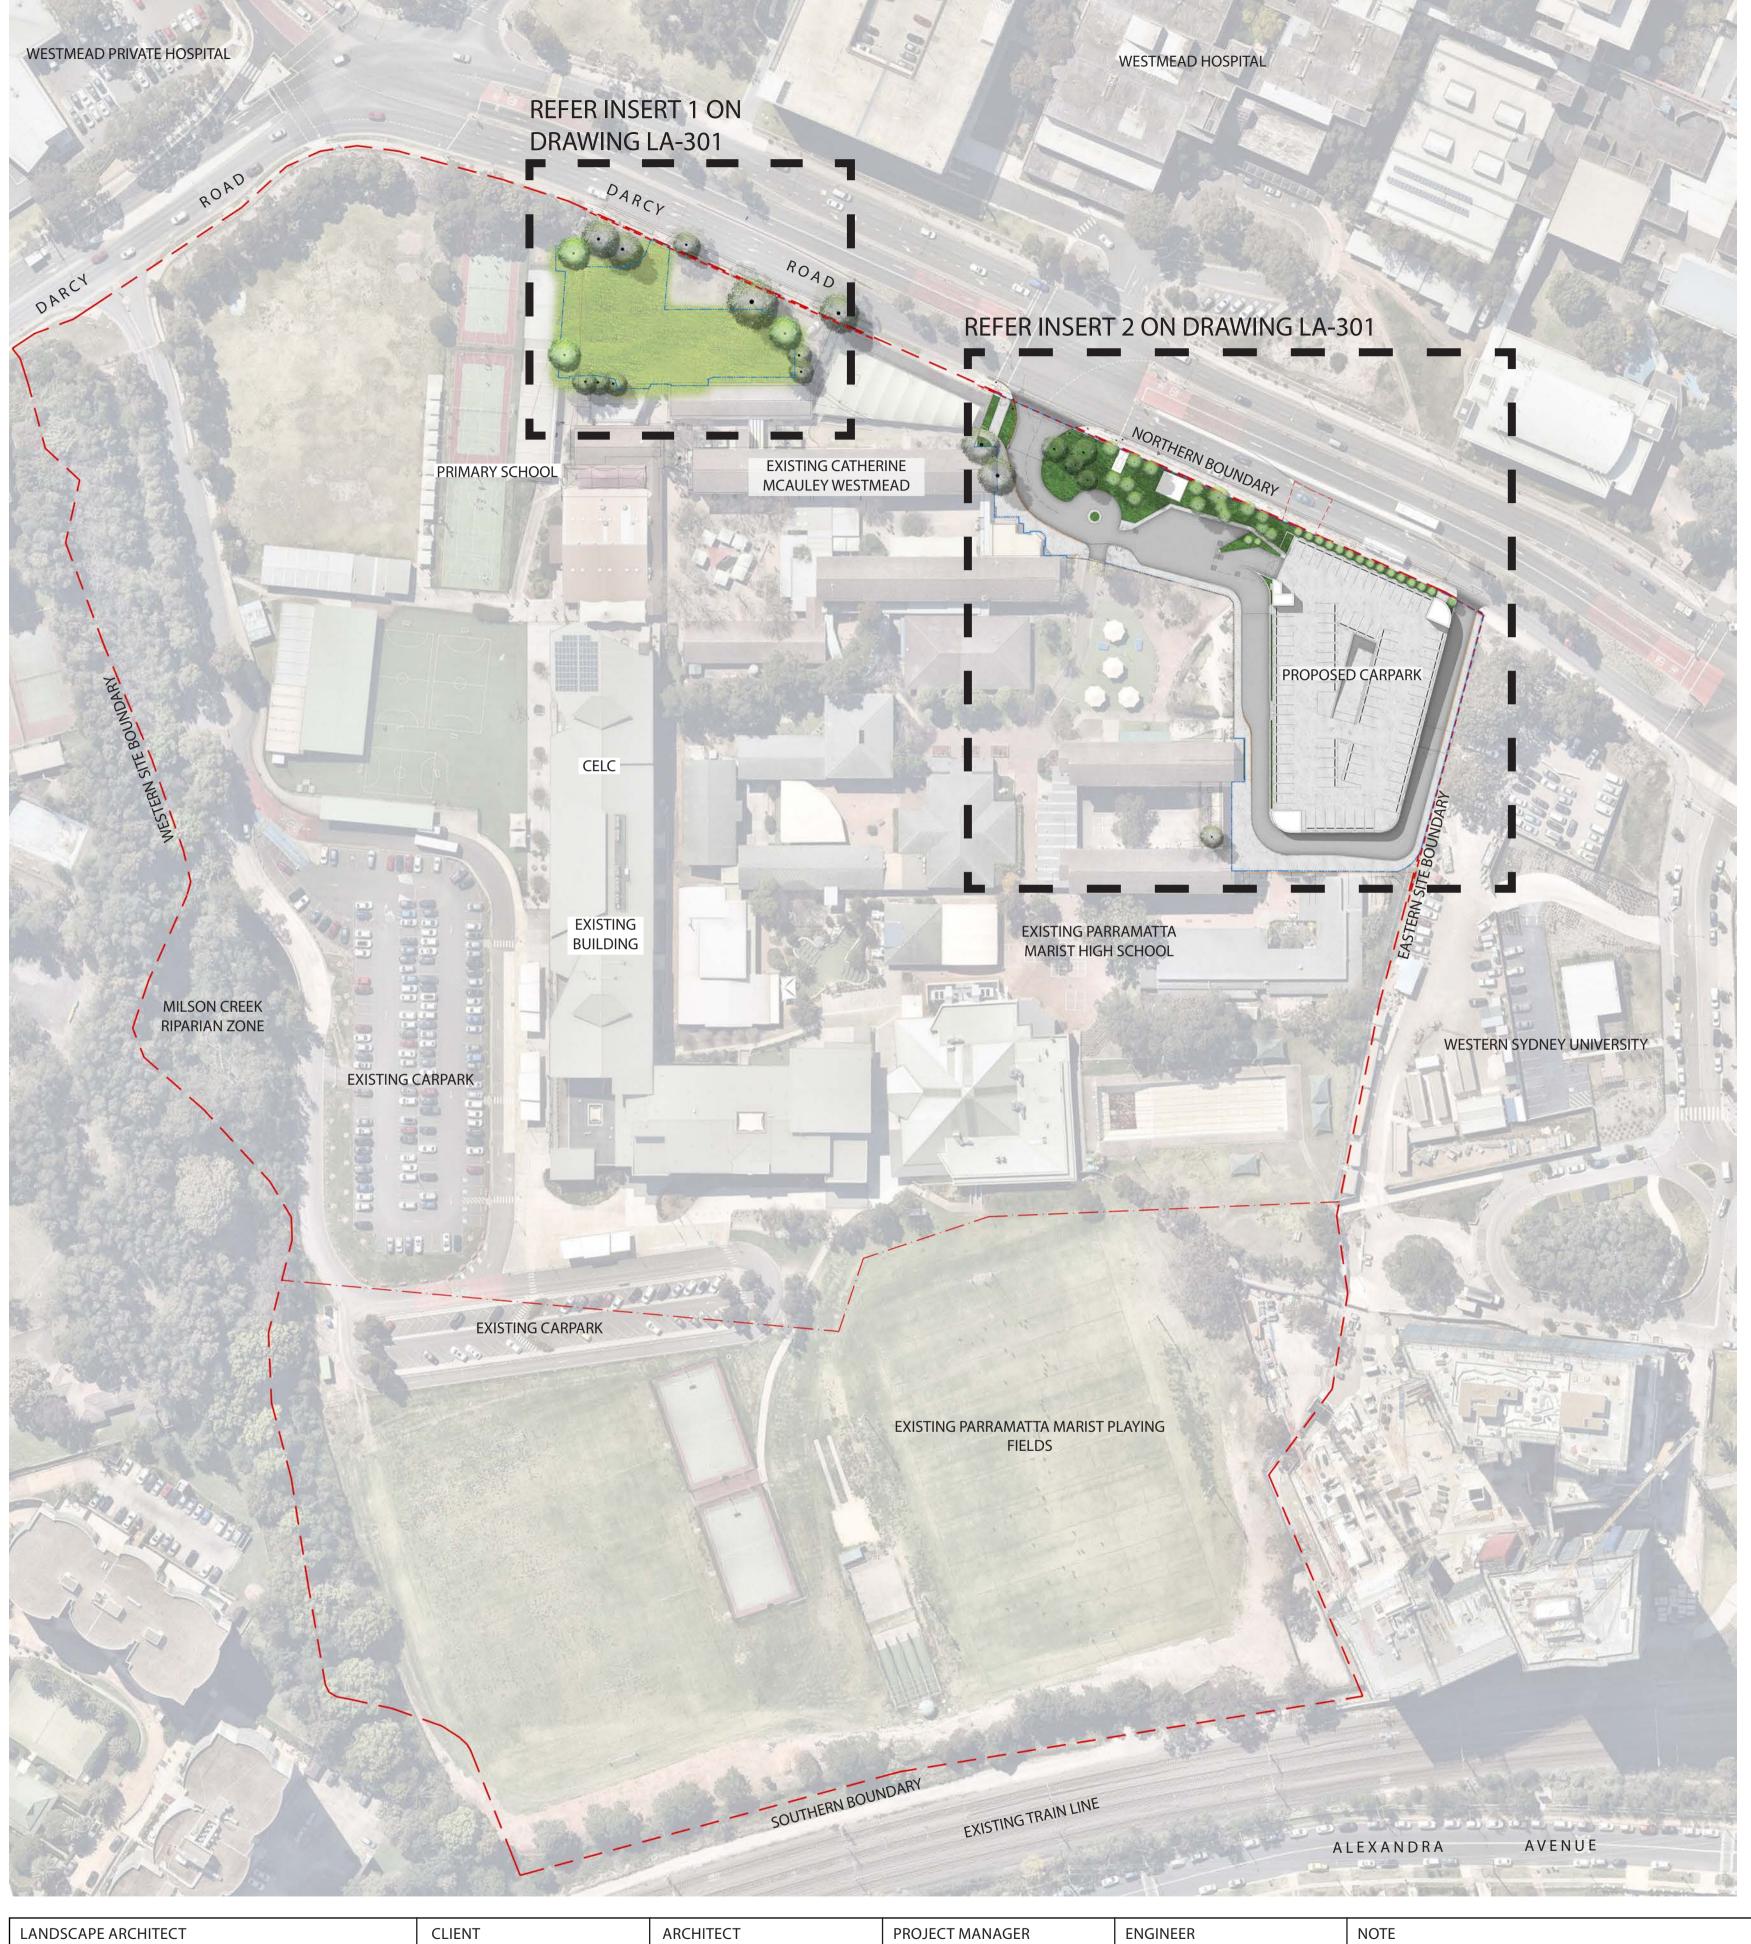

FOR DEVELOPMENT APPLICATION

GROUND INK DIOCESE of PARRAMATTA

SUITE 201, 75 ARCHER ST, CHATSWOOD NSW 2067 PH. (02) 9411 3279 WWW.GROUNDINK.COM.AU ABN 55 163 025 456 ACN 163 025 456 © GROUND INK PTY LTD THIS DESIGN AND DRAWING IS PROTECTED BY COPYRIGHT.

LEVEL 1, 695-699 GEORGE STREET 12 VICTORIA RD, PARRAMATTA NSW 2150 PH. (02) 8838 3400 HAYMARKET, NSW 2000 https://parracatholic.org/ PH. (02) 8039 8822 https://www.alleanza.com.au/

214 / 40 YEO STREET NEUTRAL BAY, NSW 2089 PH. (02) 8021 7667

https://winim.com.au/

NORTHROP

LEVEL 11, 345 GEORGE STREET SYDNEY, NSW 2000 PH. (02) 9241 4188 https://northrop.com.au/

VERIFY ALL DIMENSIONS ON SITE BEFORE COMMENCING WORK. REPORT ALL DISCREPANCIES TO LANDSCAPE ARCHITECT PRIOR TO CONSTRUCTION. FIGURED DIMENSIONS TO BE TAKEN IN PREFERENCE TO SCALED DRAWINGS. ALL WORK IS TO CONFORM TO RELEVANT AUSTRALIAN STANDARDS AND OTHER CODES AS APPLICABLE. LOCATION OF UNDERGROUND SERVICES TO BE PROVEN ON SITE AND PROTECTED IF NECESSARY PRIOR TO CONSTRUCTION. DIAL BEFORE YOU DIG.PLANT SPECIES AND QUANTITIES SHOWN ARE INDICATIVE ONLY AND ARE SUBJECT TO CHANGE BASED ON FUTURE PROJECT REQUIREMENTS.

	REVISION	DATE	DESCRIPTION	DRAWN	CHECKED	DRAWING TITLE
	А	03 APR 20	FOR DEVELOPMENT APPLICATION	MC	RL	
	В	16 JUL 20	REVISED DEVELOPMENT APPLICATION	NS	RL	
						LANDSCADE MASTERDI ANI
) TV						LANDSCAPE MASTERPLAN
*						

. v					1 4 1	<i>/</i> (1 1	LIC/TITOTY
	DATE		JOB NU	MBER	DRAWN	CHECKED	DRAWING NUMBER
	16-Ju	l-20	201907	22	MC	RL	LA-101
	PROJE	ECT					
		_	EAD (ISW 2145	CATH	HOLIC	COMMU	JNITY
	SCAL	E					REV
	1:10	000 / A	41				Α
	0 I	10 I	20 I	30 I	40M I		


EXISTING TREE SCHEDULE

ID DESCRIPTION

BOLUSANTHUS SP. (TREE WISTERIA)

CALLISTEMON VIMINALIS (WEEPING BOTTLEBRUSH)

2	CALLISTEMON VIMINALIS (WEEPING BOTTLEBRUSH)	10m	REMOVE
3	CALLISTEMON VIMINALIS (WEEPING BOTTLEBRUSH)	6m	REMOVE
4	ARCHONTOPHOENIX CUNNINGHAMIANA (BANGALOW PALM)	7m	REMOVE
5	CALLISTEMON VIMINALIS (WEEPING BOTTLEBRUSH)	10	REMOVE
6	JACARANDA MIMOSIFOLIA (JACARANDA)	5m	REMOVE
7	ULMUS PARVIFOLIA (CHINESE WEEPING ELM)	9m	REMOVE
8	ULMUS PARVIFOLIA (CHINESE WEEPING ELM)	6m	REMOVE
9	CALLISTEMON VIMINALIS (WEEPING BOTTLEBRUSH)	5m	REMOVE
10	QUERCUS PALUSTRIS (PIN OAK)	14m	REMOVE
11	QUERCUS PALUSTRIS (PIN OAK)	11m	REMOVE
12	QUERCUS PALUSTRIS (PIN OAK)	12m	REMOVE
13	QUERCUS PALUSTRIS (PIN OAK)	12m	REMOVE
14	BRACHYCHITON RUPESTRI (BOTTLE TREE)	9m	REMOVE
15	LOPHOSTEMON CONFERTUS (BRUSH BOX)	6m	REMOVE
	LOPHOSTEMON CONFERTUS 'VARIEGATA' (VARIEGATED		
16	BRUSH BOX)	7m	REMOVE
17	LIQUIDAMBER STYRACIFLUA (LIQUIDAMBER)	5m	REMOVE
18	LOPHOSTEMON CONFERTUS (BRUSH BOX)	7m	REMOVE
19	FRAXINUS SP. (ASH)	10m	RETAINED
20	CAMELLIA SASANQUA (CAMELLIA)	7m	RETAINED
21	LOPHOSTEMON CONFERTUS (BRUSH BOX)	8m	RETAINED
22	LOPHOSTEMON CONFERTUS (BRUSH BOX)	8m	REMOVE
23	BRACHYCHITON RUPESTRI (BOTTLE TREE)	9m	REMOVE
24	JACARANDA MIMOSIFOLIA (JACARANDA)	9m	RETAINED
25	LOPHOSTEMON CONFERTUS (BRUSH BOX)	8m	RETAINED
26	LOPHOSTEMON CONFERTUS (BRUSH BOX)	7m	RETAINED
27	PHOENIX CANARIENSIS (CANARY ISLAND DATE PALM)	8m	RETAINED
28	SYAGRUS ROMANZOFFIANUM (COCOS PALM)	12m	REMOVE
29	CALLISTEMON VIMINALIS (WEEPING BOTTLEBRUSH)	5m	RETAINED
30	LIQUIDAMBER STYRACIFLUA (LIQUIDAMBER)	8m	RETAINED
	FLINDERSIA AUSTRALIS (CROW'S ASH)		
31		14m	REMOVE
32	ULMUS PARVIFOLIA (CHINESE WEEPING ELM)	7m	REMOVE
33	ULMUS PARVIFOLIA (CHINESE WEEPING ELM)	6m	RETAINED
34	BAUHINIA VARIEGATA (BUTTERFLY TREE)	5m	RETAINED
35	COTONEASTER SP. (COTONEASTER)	4m	RETAINED
46	PLATANUS XACERIFOLIA (LONDON PLANE)	14m	RETAINED
47	PLATANUS XACERIFOLIA (LONDON PLANE)	11m	REMOVE
48	FRAXINUS SP. (ASH)	5m	REMOVE
49	FRAXINUS SP. (ASH)	13m	REMOVE
50	CELTIS AUSTRALIS (HACKBERRY)	11m	REMOVE
51	PLATANUS XACERIFOLIA (LONDON PLANE)	11m	REMOVE
83	CASUARINA GLAUCA (SWAMP SHE OAK)	14m	RETAINED
84	PINUS RADIATA (MONTEREY PINE)	14m	RETAINED
85	PINUS RADIATA (MONTEREY PINE)	14m	RETAINED
86	CINNAMOMUM CAMPHORA (CAMPHOR LAUREL)	13m	RETAINED
87	EUCALYPTUS BOTRYOIDES (BANGALAY)	15m	RETAINED
88	EUCALYPTUS BOTRYOIDES (BANGALAY)	10m	RETAINED
89	EUCALYPTUS CREBRA (NARROW LEAF IRONBARK)	11m	RETAINED
90	EUCALYPTUS CREBRA (NARROW LEAF IRONBARK)	12m	RETAINED
95	ULMUS PROCERA (GREEN ENGLISH ELM)	11m	REMOVE
96	PLATANUS XACERIFOLIA (LONDON PLANE)	15m	RETAINED
97	FICUS MICROCARPA 'HILLI' (HILLS WEEPING FIG)	9m	REMOVE
98	CALLISTEMON VIMINALIS (WEEPING BOTTLEBRUSH)	9m	REMOVE
		9111 9m	
99	SPATHODEA CAMPANULATA (AFRICAN TULIP TREE)		REMOVE
149	CASUARINA CUNNINGHAMIANA (RIVER SHE OAK)	12m	RETAINED
150	CASUARINA CUNNINGHAMIANA (RIVER SHE OAK)	6m	RETAINED
183	CUPRESSUS SP. (CYPRESS PINE)	12m	REMOVE
184	QUERCUS PALUSTRIS (PIN OAK)	14m	REMOVE
			REMOVE

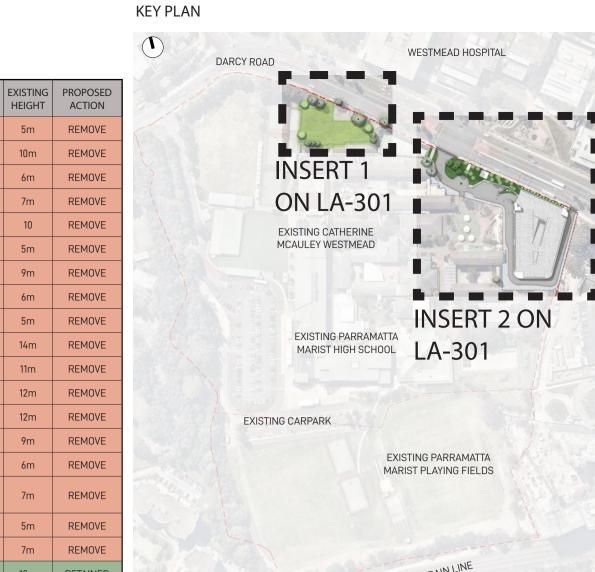

ALEXANDRA AVENUE

LEGEND

5m REMOVE 10m REMOVE



EXISTING TREE TO BE RETAINED



EXISTING TREE TO BE REMOVED

EOD DEVELODMENT ADDITION



© GROUND INK PTY LTD THIS DESIGN AND DRAWING IS PROTECTED BY COPYRIGHT.





LEVEL 1, 695-699 GEORGE STREET

https://www.alleanza.com.au/

HAYMARKET, NSW 2000

PH. (02) 8039 8822

214 / 40 YEO STREET NEUTRAL BAY, NSW 2089 PH. (02) 8021 7667

https://winim.com.au/

PROJECT MANAGER



LEVEL 11, 345 GEORGE STREET

SYDNEY, NSW 2000


PH. (02) 9241 4188

https://northrop.com.au/

NOTE VERIFY ALL DIMENSIONS ON SITE BEF DISCREPANCIES TO LANDSCAPE ARCI DIMENSIONS TO BE TAKEN IN PREFER IS TO CONFORM TO RELEVANT AUSTRA APPLICABLE. LOCATION OF UNDERGR PROTECTED IF NECESSARY PRIOR TO SPECIES AND QUANTITIES SHOWN ARE CHANGE BASED ON FUTURE PROJECT

	REVISION	DATE	DESCRIPTION	DRAWN	CHECKED	DRAWING TITLE
BEFORE COMMENCING WORK, REPORT ALL	Α	03 APR 20	FOR DEVELOPMENT APPLICATION	MC	RL	
RCHITECT PRIOR TO CONSTRUCTION. FIGURED	В	16 JUL 20	REVISED DEVELOPMENT APPLICATION	NS	RL	
FERENCE TO SCALED DRAWINGS. ALL WORK						
TRALIAN STANDARDS AND OTHER CODES AS						EVICTIMIC TOES
RGROUND SERVICES TO BE PROVEN ON SITE AND TO CONSTRUCTION. DIAL BEFORE YOU DIG.PLANT						EXISTING TREE
ARE INDICATIVE ONLY AND ARE SUBJECT TO						
ECT REQUIREMENTS.						

FOR DEV	ELO	PIME	IN I	APPLI	CAHON
	DATE 16-Jul-20	JOB NUMBER 20190722	DRAWN MC	CHECKED RL	DRAWING NUMBER LA-201
E PLAN	PROJECT WESTM WESTMEAD, N		HOLIC	COMMUNIT	Y
	SCALE 1:500/A1	8 12 16 I I I	20m		REV A

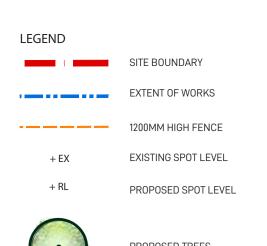


PROPOSED TREES

MASS PLANTING CONSISTING OF MIXED SHRUBS, GRASSES AND GROUNDCOVERS REFER TO INDICATIVE PLANT PALETTE ON DRAWING LA-601 FOR FURTHER DETAILS

EXISTING TREES TO BE RETAINED REFER TO DRAWING LA201 FOR FURTHER DETAILS.



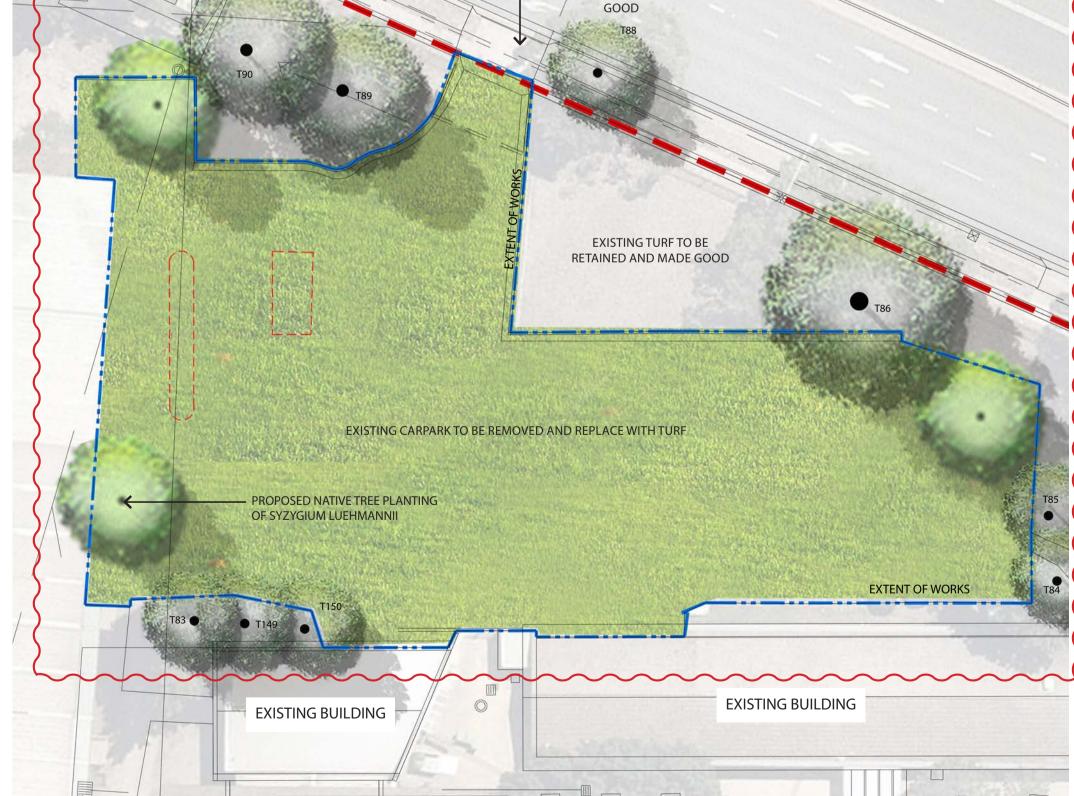

INSERT 1

LANDSCAPE ARCHITECT GROUND INK

SUITE 201, 75 ARCHER ST, CHATSWOOD NSW 2067 PH. (02) 9411 3279 WWW.GROUNDINK.COM.AU ABN 55 163 025 456 ACN 163 025 456

© GROUND INK PTY LTD THIS DESIGN AND DRAWING IS PROTECTED BY COPYRIGHT.

CLIENT

PH. (02) 8838 3400

https://parracatholic.org/

LEVEL 1, 695-699 GEORGE STREET 12 VICTORIA RD, PARRAMATTA NSW 2150 HAYMARKET, NSW 2000 PH. (02) 8039 8822 https://www.alleanza.com.au/

ARCHITECT

EXISTING VEHICLE CROSSING

TO BE REMOVED AND MADE

PROJECT MANAGER 214 / 40 YEO STREET

NEUTRAL BAY, NSW 2089

PH. (02) 8021 7667

https://winim.com.au/

NORTHROP

LEVEL 11, 345 GEORGE STREET

SYDNEY, NSW 2000

https://northrop.com.au/

PH. (02) 9241 4188

VERIFY ALL DIMENSIONS ON SITE BEFORE COMMENCING WORK. REPORT ALL DISCREPANCIES TO LANDSCAPE ARCHITECT PRIOR TO CONSTRUCTION. FIGURED DIMENSIONS TO BE TAKEN IN PREFERENCE TO SCALED DRAWINGS. ALL WORK IS TO CONFORM TO RELEVANT AUSTRALIAN STANDARDS AND OTHER CODES AS APPLICABLE. LOCATION OF UNDERGROUND SERVICES TO BE PROVEN ON SITE AND PROTECTED IF NECESSARY PRIOR TO CONSTRUCTION. DIAL BEFORE YOU DIG.PLANT SPECIES AND QUANTITIES SHOWN ARE INDICATIVE ONLY AND ARE SUBJECT TO CHANGE BASED ON FUTURE PROJECT REQUIREMENTS.

PROPOSED PEDESTRIAN GATE

PROPOSED TREES OF WATERHOUSEA

PROPOSED TREES OF WATERHOUSEA

—EXISTING SUBSTATION

PROPOSED SLIDING GATE

PROPOSED MIXED SHRUB

PLANTING OF ACACIA,

03 APR 20 FOR DEVELOPMENT APPLICATION MC RL NS RL 16 JUL 20 REVISED DEVELOPMENT APPLICATION

JOB NUMBER DRAWN CHECKED LA-301 16-Jul-20 20190722 MC RL NORTH WESTMEAD CATHOLIC COMMUNITY CARPARK WESTMEAD, NSW 2145 LANDSCAPE PLAN REV 1:250 / A1 0 2 4 6 8 10m I I I I I

KEY PLAN

WESTMEAD HOSPITAL

TREES









SHRUBS















GRASSES & GROUNDCOVERS














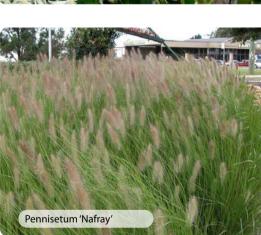





INDICATIVE PLANT PALETTE

BOTANICAL NAME	COMMON NAME	MATURE HEIGHT	QUANTITIES	NATIVE
TREES	'			
ELAEOCARPUS RETICULATUS	BLUEBERRY ASH	15M	16	\checkmark
SYZYGIUM LUEHMANNII	RIBERRY LILLY PILLY	15M	6	\checkmark
TRISTANIOPSIS LAURINA	WATER GUM	15M	7	\checkmark
WATERHOUSEA FLORIBUNDA	WEEPING LILLY PILLY	12M	6	\checkmark
SHRUBS				
ADENANTHOS 'SILVER LINING'	WOOLLY BUSH	0.6M	N / A	\checkmark
ACACIA 'MINI COG'	BOWER WATTLE	0.6M	N / A	\checkmark
BANKSIA 'BIRTHDAY CANDLES'	HAIRPIN BANKSIA	0.5M	N / A	\checkmark
CRASSULA 'BLUE BIRD'	JADE PLANT	0.6M	N / A	
DORYANTHES EXCELSA	GYMEA LILY	3M	N / A	√
EREMOPHILA 'BLUE HORIZON'	TAR BUSH	0.4M	N / A	✓
GREVILLEA LONGIFOLIA	FERN-LEAF SPIDER FLOWER	1.5M	N / A	√
OZOTHAMNUS DIOSMIFOLIUS	RICE FLOWER	0.8M	N / A	√
SYZYGIUM 'AUSSIE BOOMER'	LILLY PILLY	2.5M	N / A	√
WESTRINGIA FRUTICOSA	COASTAL ROSEMARY	2M	N / A	J
GRASSES AND GROUNDCOVERS				
ANIGOZANTHOS 'AMBER VELVET'	KANGAROO PAW	0.5M	N / A	√
CALLISTEMON 'RED ROVER'	BOTTLE BRUSH	0.4M	N / A	\checkmark
CARPOBROTUS GLAUSESCENS	PIGFACE	TRAILING	N / A	J
CLEMATIS ARISTATA	OLD MAN'S BEARD	TRAILING	N / A	J
DIANELLA CAERULEA	BLUE FLAX LILY	1M	N / A	√
HARDENBERGIA VIOLACEA	NATIVE SARSAPARILLA	0.8M	N / A	\checkmark
LIRIOPE 'JUST RIGHT'	LILY TURF	0.5M	N / A	
LOMANDRA LONGIFOLIA	BASKET RUSH	1M	N / A	\checkmark
MYOPORUM PARVIFOLIUM	CREEPING BOOBIALLA	TRAILING	N / A	✓
PENNISETUM 'NAFRAY'	DWARF FOUNTAIN GRASS	0.6M	N / A	V
SENECIO SERPENS	BLUE CHALKSTICKS	TRAILING	N / A	
TRACHELOSPERMUM 'TRICOLOUR'	STAR JASMINE	TRAILING		

OUTLINE LANDSCAPE SPECIFICATION

Maintenance shall mean the care and maintenance of the landscape works by accepted horticultural practice as rectifying any defects that become apparent in the landscape works under normal use. The landscape contractor shall attend the site on a weekly basis to maintain the landscape works for the full term approved at CC stage of the maintenance period (commencing from practical completion).

Rubbish Removal

During the term of the maintenance period the Landscape Contractor shall undertake rubbish removal from the site on a weekly basis to ensure the site remains in tidy condition.

Weed Eradication

Weed growth that may occur in, planted or mulched areas is to be removed using environmentally acceptable methods i.e. non-residual glyphosate herbicide, (e.g. 'Roundup', applied in accordance with the manufacturer's directions) or hand

Tree Replacement

Trees shall show signs of healthy vigorous growth and be free from disease and not exhibit signs of stress prior to handover to the client. Any trees or plant that die or fail to thrive, or are damaged or stolen will be replaced. Replacement material shall have the maintenance period extended in accordance with the landscape contract conditions. Trees and plant materials shall be equal to the minimum requirements of species specified and approved material delivered to site. Should the condition decline from the approved sample the Superintendent reserves the right to reject the tree / plants. Frequency: as required.

Selective pruning may be required during the establishment period to promote a balanced canopy structure. These activities shall be carried out to the best horticultural and industry practice. All pruned material is to be removed from site.

A low volume drip irrigation system may be installed at the discretion of the Developer. Position of control box, solenoids and irrigation conduits to be designed by qualified irrigation engineer at CC stage

Controllers shall be mounted on a stable wall, power rack, or formed and constructed concrete based pedestal mount. Performance specification to be provided by landscape architect, nominally 25mm delivered to

DATE DESCRIPTION

plant areas each week during establishment (depending on weather conditions). After establishment, irrigation rates can be decreased in certain areas of the landscape depending on

Watering

Implement an appropriate hand watering regime in areas not irrigated in association with current watering programme to maintain plant health and vigour. The program shall reflect seasonal conditions and plant species. Frequency: Weekly or as required.

Drainage

All landscape areas are to have positive drainage to SW systems. If areas of poor drainage are identified on site then this should be brought to the site superintendents attention. Install agg lines if required.

Horizon A - Garden beds on natural ground

A sandy loam to clay loam topsoil mix designed for general purpose, on-grade landscape garden bed planting of grasses, woody and herbaceous annuals and perennials that have high nutrient requirement for sustained optimum growth, and are not subject to compaction by pedestrian and

other foot traffic. Heavier textured soils in this specification may require engineered solutions where excessive wetness is anticipated. Note that organic soil variant should not be chosen for low P plantings and should not be used below 300mm. Planting methods include direct seeding, tube and potted specimens up to 45L

All garden beds to be cultivated to a min depth of 150mm and tree pits to the depth of the root ball only. If additives such as gypsum are required conduct this after cultivation into the top 100mm of soil.

All planting to be grown to NATSPEC specifications. Contractor to prepare site for planting including watering, handling, setting out and excavation. Excavate a hole for each plant large enough to provide not less than 100mm all around the root system of the plant. For tree planting each hole shall be dug with a shovel, backhoe or similar tool. Individual holes shall be excavated to allow root system to sit flat on the excavated hole and 400mm to each side of the root system. Backfill planting holes with existing site soil and topsoil as described in section 'Soil', plant / Tree shall be set plumb, with

the root ball set slightly below the final soil level.

Mulching

The Landscape Contractor shall supply and install 10mm Pine Bark Mulch to all garden beds shown on the landscape plans, to a minimum depth of 75mm. All mulch is to be free of deleterious matter such as soil, weeds and sticks. Mulched surfaces are to be kept clean and tidy and free of any deleterious material and foreign matter. Reinstate depths to a uniform level of 75mm with mulch as specified, mulch to be free of any wood material impregnated with CCA or similar toxic treatment. Maintain watering rings around trees. Top up mulch levels prior to handover to client.

Turfing

The landscape contractor shall supply and install Sapphire Buffalo turf in stretcher pattern to all turf areas shown on the landscape plans and is to finish flush with adjacent surfaces. Turf to be a min thickness of 50mm with a 40mm mowing height. Contractor to allow for fertilising, laying, tamping, watering, top dressing, maintenance and mowing. The landscape contractor shall supply and install turf underlay under all turf areas, consisting of 100mm thick layer of screened top soil.

Pest and Disease Control

The Landscape Contractor shall spray for pests and disease infestations when the pest and fungal attack has been positively identified and when their populations have increased to a point that will become detrimental to plant growth. Apply all pesticides to manufacturer's directions.

Frequency: weekly inspection

Fertilising

Pellets shall be in the form intended to uniformly release plant food elements for a period of approximately nine months equal to Shirleys KOKEI pellets, analysis 6.3:1.8:2.9 or similar approved. KOKEI pellets shall be placed at the time of planting to the base of the plant, 50mm minimum from the root ball at a rate of two pellets per 300mm of top growth to a maximum of 8 pellets per tree. Generally check for signs of nutrient deficiencies (yellowing of leaves, failure to thrive), and adapt fertiliser regime to suit. Fertiliser should be applied at the beginning and the end of the (summer) growing season.



FOR DEVELOPMENT APPLICATION

LANDSCAPE ARCHITECT GROUND INK SUITE 201, 75 ARCHER ST, CHATSWOOD NSW 2067 PH. (02) 9411 3279

WWW.GROUNDINK.COM.AU ABN 55 163 025 456 ACN 163 025 456

© GROUND INK PTY LTD THIS DESIGN AND DRAWING IS PROTECTED BY COPYRIGHT.



https://parracatholic.org/



HAYMARKET, NSW 2000

https://www.alleanza.com.au/

PH. (02) 8039 8822



PH. (02) 8021 7667

https://winim.com.au/



ENGINEER

SYDNEY, NSW 2000

https://northrop.com.au/

PH. (02) 9241 4188

NOTE VERIFY ALL DIMEN DISCREPANCIES T DIMENSIONS TO BE IS TO CONFORM TO APPLICABLE. LOCA PROTECTED IF NEC SPECIES AND QUAR CHANGE BASED ON

	NE.
NSIONS ON SITE BEFORE COMMENCING WORK. REPORT ALL	
TO LANDSCAPE ARCHITECT PRIOR TO CONSTRUCTION. FIGURED	
BE TAKEN IN PREFERENCE TO SCALED DRAWINGS. ALL WORK	
O RELEVANT AUSTRALIAN STANDARDS AND OTHER CODES AS	
ATION OF UNDERGROUND SERVICES TO BE PROVEN ON SITE AND	
CESSARY PRIOR TO CONSTRUCTION. DIAL BEFORE YOU DIG.PLANT	
ANTITIES SHOWN ARE INDICATIVE ONLY AND ARE SUBJECT TO	
IN FUTURE PROJECT REQUIREMENTS.	

DRAWING TITLE

リEV	ELO	PIVIE	IN I	APP	LICATION		
	DATE 16-Jul-20	JOB NUMBER 20190722	DRAWN MC	CHECKED RL	DRAWING NUMBER LA-501		
	PROJECT						
	WESTMEAD CATHOLIC COMMUNITY WESTMEAD, NSW 2145						
	SCALE				REV		
	1:20 / A1				В		

WESTMEAD CATHOLIC COMMUNITY - CARPARK

DARCY ROAD, WESTMEAD CIVIL DOCUMENTATION





CIVIL DRAWING SCHEDULE

DWG No. DRAWING TITLE

COVER SHEET, DRAWING SCHEDULE AND LOCALITY PLAN

SPECIFICATION NOTES

GENERAL ARRANGEMENT PLAN CONCEPT SEDIMENT AND EROSION CONTROL PLAN

DIAL BEFORE YOU DIG www.1100.com.au


NOT FOR CONSTRUCTION

1 ISSUED FOR DA

DESCRIPTION

VERIFICATION SIGNATURE HAS BEEN ADDED

NN 27.03.20

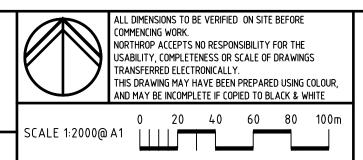

SOURCE: NEARMAP.COM.AU (©2019)



CARPARK

WESTMEAD CATHOLIC COMMUNITY DARCY ROAD, WESTMEAD

CIVIL DOCUMENTATION

COVER SHEET, DRAWING SCHEDULE AND LOCALITY PLAN 192734

DRAWING NUMBER DRAWING SHEET SIZE = A1

LOCALITY PLAN

NORTHROP CONSULTING ENGINEERS PTY LTD

- ALL DIMENSIONS ARE IN MILLIMETRES & ALL LEVELS ARE IN METRES, UNO (UNLESS NOTED OTHERWISE).
- NO DIMENSION SHALL BE OBTAINED BY SCALING THE DRAWINGS.
- ALL LEVELS AND SETTING OUT DIMENSIONS SHOWN ON THE DRAWINGS SHALL BE CHECKED ON SITE PRIOR TO THE COMMENCEMENT OF THE WORK.
- DETAIL SURVEY DATA WAS SUPPLIED BY VINCE MORGAN SURVEYORS, DRAWING DATED 21.10.19.

EXISTING SERVICES WHERE SHOWN HAVE BEEN PLOTTED FROM SUPPLIED DATA AND SUCH THEIR ACCURACY CAN NOT BE GUARANTEED. IT IS THE RESPONSIBILITY OF THE CONTRACTOR TO ESTABLISH THE LEVEL OF ALL EXISTING SERVICES PRIOR TO THE COMMENCEMENT OF WORK.

CONTRACTOR TO INVESTIGATE LOCATION AND INVERT LEVELS OF EXISTING STORMWATER NETWORK AND ADVICE NORTHROP OF ANY DISCREPANCY.

ON COMPLETION OF STORMWATER INSTALLATION, ALL DISTURBED AREAS MUST BE RESTORED TO ORIGINAL CONDITION, INCLUDING KERBS, FOOTPATHS, CONCRETE AREAS, GRAVEL AND GRASSED AREAS AND ROAD PAVEMENTS, UNLESS DIRECTED OTHERWISE.

ACCESS AND SAFETY

- THE CONTRACTOR SHALL COMPLY WITH ALL STATUTORY AND INDUSTRIAL REQUIREMENTS FOR PROVISION OF A SAFE WORKING ENVIRONMENT INCLUDING TRAFFIC CONTROL.
- THE CONTRACTOR SHALL PROVIDE TRAFFIC MANAGEMENT PLANS FOR THE PROPOSED WORKS COMPLETED BY A SUITABLY QUALIFIED PERSON AND APPROVED BY COUNCIL / REGULATORY AUTHORITY. WORK IS NOT TO COMMENCE ON SITE PRIOR TO APPROVAL OF TRAFFIC MANAGEMENT SCHEME.
- THE CONTRACTOR SHALL ENSURE THAT AT ALL TIMES ACCESS TO BUILDINGS ADJACENT THE WORKS IS NOT DISRUPTED.
- WHERE NECESSARY THE CONTRACTOR SHALL PROVIDE SAFE PASSAGE OF VEHICLES AND/OR PEDESTRIANS THROUGH OR BY THE
- THE CONTRACTOR SHALL ENSURE PUBLIC ACCESS EXTERNAL TO THE SITE IS IN ACCORDANCE WITH COUNCILS / AUTHORITY / SITE MANAGERS REQUIREMENTS.

EXISTING SERVICES

- ALL UTILITY SERVICES INDICATED ON THE DRAWINGS ORIGINATE FROM SUPPLIED DATA OR DIAL BEFORE YOU DIG SEARCHES. THEREFORE THEIR ACCURACY AND COMPLETENESS IS NOT GUARANTEED. IT IS THE RESPONSIBILITY OF THE CONTRACTOR TO DETERMINE AND CONFIRM THE LOCATION AND LEVEL OF ALL EXISTING SERVICES PRIOR TO THE COMMENCEMENT OF ANY WORK. ANY DISCREPANCIES SHALL BE REPORTED TO THE SUPERINTENDENT CLEARANCES SHALL BE OBTAINED FROM THE RELEVANT SERVICE AUTHORITY. NOTE SERVICE AUTHORITY REQUIREMENTS FOR LOCATING OF SERVICES PRIOR TO COMMENCEMENT OF WORKS.
- CARE TO BE TAKEN WHEN EXCAVATING NEAR EXISTING SERVICES. NO MECHANICAL EXCAVATIONS ARE TO BE UNDERTAKEN OVER COMMUNICATION, GAS OR ELECTRICAL SERVICES. HAND EXCAVATION ONLY IN THESE AREAS.
- THE CONTRACTOR SHALL PROTECT AND MAINTAIN ALL EXISTING SERVICES THAT ARE TO BE RETAINED IN THE VICINITY OF THE PROPOSED WORKS, ANY AND ALL DAMAGE TO THESE SERVICES AS A RESULT OF THESE WORKS SHALL BE REPAIRED BY THE CONTRACTOR UNDER THE DIRECTION OF THE SUPERINTENDENT AT THE CONTRACTORS EXPENSE.
- THE CONTRACTOR SHALL ALLOW IN THE PROGRAM FOR THE ADJUSTMENT (IF REQUIRED) OF EXISTING SERVICES IN AREAS AFFECTED BY WORKS.
- THE CONTRACTOR SHALL ALLOW IN THE PROGRAM FOR THE CAPPING OFF, EXCAVATION AND REMOVAL (IF REQUIRED) OF EXISTING SERVICES IN AREAS AFFECTED BY WORKS UNLESS DIRECTED OTHERWISE ON THE DRAWINGS OR BY THE SUPERINTENDENT.
- THE CONTRACTOR SHALL ENSURE THAT AT ALL TIMES SERVICES TO ALL BUILDINGS ARE NOT AFFECTED BY THE WORKS AND ARE MAINTAINED AND NOT DISRUPTED.
- PRIOR TO COMMENCEMENT OF ANY WORKS THE CONTRACTOR SHALL GAIN APPROVAL OF THE PROGRAM FOR THE RELOCATION AND/OR CONSTRUCTION OF TEMPORARY SERVICES AND FOR ANY ASSOCIATED INTERRUPTION OF SUPPLY.
- THE CONTRACTOR SHALL CONSTRUCT TEMPORARY SERVICES TO MAINTAIN EXISTING SUPPLY TO BUILDINGS REMAINING IN OPERATION DURING WORKS TO THE SATISFACTION AND APPROVAL OF THE SUPERINTENDENT. ONCE DIVERSION IS COMPLETE AND COMMISSIONED THE CONTRACTOR SHALL REMOVE ALL SUCH TEMPORARY SERVICES AND MAKE GOOD TO THE SATISFACTION OF THE SUPERINTENDENT.
- THE CONTRACTOR IS TO ALLOW TO POTHOLE ANY SERVICES WITHIN A PUBLIC RESERVE WITHIN THE EXTENT OF WORKS (E.G. STORMWATER CROSSINGS).

DESCRIPTION

EVISION

1 ISSUED FOR DA

SITEWORKS

- ALL WORKS TO BE IN ACCORDANCE WITH RELEVANT LOCAL COUNCIL. REGULATORY AUTHORITIES REQUIREMENTS. ALL SPECIFICATIONS AND AUSTRALIAN STANDARDS. CONFLICTS BETWEEN SAID DOCUMENTS SHALL BE REFERRED TO THE SUPERINTENDENT FOR DIRECTION.
- THE CONTRACTOR IS TO REVIEW THE DRAWINGS PRIOR TO PRICING AND COMMENCEMENT AND REPORT ANY DISCREPANCIES TO NORTHROP
- ANY PRODUCTS SPECIFIED OR USED TO BE VERIFIED BY THE CONTRACTOR AS BEING SAFE AND APPROPRIATE FOR USE. NORTHROP DO NOT TAKE ANY RESPONSIBILITY FOR THE USE OF UNSAFE PRODUCTS
- THE CONTRACTOR IS TO DESIGN. OBTAIN APPROVALS AND CARRY OUT REQUIRED TEMPORARY TRAFFIC CONTROL PROCEDURES DURING CONSTRUCTION IN ACCORDANCE WITH ALL REGULATORY AUTHORITIES, INCLUSIVE OF LOCAL COUNCIL REGULATIONS AND REQUIREMENTS.
- THE CONTRACTOR IS TO OBTAIN ALL AUTHORITY APPROVALS AS REQUIRED PRIOR TO COMMENCEMENT OF WORKS.
- 6. RESTORE ALL PAVED, COVERED, GRASSED AND LANDSCAPED AREAS TO THEIR ORIGINAL CONDITION OR AS DIRECTED BY THE SITE SUPERINTENDENT ON COMPLETION OF WORKS. WHERE PLANTING OF NEW GRASS IS NECESSARY REFER TO LANDSCAPE ARCHITECT AND / OR ARCHITECT DOCUMENTATION.
- ON COMPLETION OF ANY TRENCHING WORKS, ALL DISTURBED AREAS SHALL BE RESTORED TO THEIR ORIGINAL CONDITION OR AS DIRECTED BY THE SITE SUPERINTENDENT, INCLUDING KERBS, FOOTPATHS, CONCRETE AREAS, GRAVEL, GRASSED AREAS AND ROAD PAVEMENTS.
- 8. THE CONTRACTOR SHALL ARRANGE ALL SURVEY SETOUT TO BE CARRIED OUT BY A REGISTERED SURVEYOR PRIOR TO COMMENCEMENT OF WORKS. THE CONTRACTOR IS TO ENSURE THAT SURVEY BOUNDARIES ARE DERIVED FROM A CADASTRAL SURVEY RATHER THAN A DETAIL SURVEY.
- 9. THE CONTRACTOR SHALL VERIFY ALL DIMENSIONS AND EXISTING LEVELS ONSITE PRIOR TO LODGMENT OF TENDER AND ONSITE WORKS. THE PRICE AS TENDERED SHALL BE INCLUSIVE OF ALL WORKS SHOWN ON THE TENDER PROJECT DRAWINGS. ADDITIONAL PAYMENTS FOR WORKS SHOWN ON THE TENDER PROJECT DRAWINGS WILL NOT BE APPROVED.
- 10. DO NOT OBTAIN DIMENSIONS BY SCALING DRAWINGS.
- 11. IN CASE OF DOUBT OR DISCREPANCY REFER TO SUPERINTENDENT FOR CLARIFICATION OR CONFIRMATION PRIOR TO THE COMMENCEMENT OF CONSTRUCTION.
- 12. WHERE NEW WORKS ABUT EXISTING THE CONTRACTOR SHALL ENSURE THAT A SMOOTH EVEN PROFILE, FREE FROM ABRUPT CHANGES IS OBTAINED. MAKE SMOOTH TRANSITION TO EXISTING FEATURES AND MAKE GOOD WHERE JOINED.
- 13. TRENCHES THROUGH EXISTING ROAD AND CONCRETE PAVEMENTS SHALL BE SAWCUT TO FULL DEPTH OF CONCRETE AND A MIN 50mm IN BITUMINOUS PAVING.
- ALL CIVIL ENGINEERING DESIGN HAS BEEN DOCUMENTED UNDER THE ASSUMPTION THAT ALL NECESSARY SITE CONTAMINATION REMEDIATION WORKS HAVE BEEN SATISFACTORILY COMPLETED (IF APPLICABLE) AND THAT THE SITE IS NOT AFFECTED BY ANY SOIL STRATA OR GROUNDWATER TABLE CONTAMINATION.
- 15. NOTES ON DETAILS PROVIDED TAKE PRECEDENCE OVER SPECIFICATION NOTES UNLESS IN CONTRADICTION WITH COUNCIL/AUTHORITY SPECIFICATIONS/DETAILS. CONTRACTOR TO CONSULT WITH NORTHROP FOR ANY DISCREPANCIES.
- 16. IF THE CONTRACTOR DISCOVERS HAZARDOUS/CONTAMINATED MATERIAL THE CONTRACTOR SHALL CONSULT WITH AN ENVIRONMENTAL SPECIALIST.
- 17. THE CONTRACTOR IS RESPONSIBLE FOR DEALING WITH COMMUNITY COMPLAINTS ASSOCIATED WITH THE WORKS UNDER THE CONTRACT AND TO COMPENSATE FOR/RECTIFY ANY DAMAGE REASONABLY CAUSED BY THE CONTRACTOR.
- 18. THE TERM 'MAKE GOOD' OR 'MAKE NEAT' IS IN REFERENCE TO THE SATISFACTION OF NORTHROP OR CERTIFYING ENGINEER. THE CONTRACTOR IS TO SEEK CLARIFICATION FROM NORTHROP OR THE CERTIFYING ENGINEER IF NECESSARY.

SERVICE TRENCHES

ISSUED VER'D APP'D DATE

TB

NN 27.03.20

19. SAWCUT EXISTING SURFACES PRIOR TO EXCAVATION. BACKFILL ALL TRENCHES UNDER EXISTING ROADS, PAVEMENTS AND PATHS WITH STABILISED SAND 5% CEMENT OR DGS40 MATERIAL (5% CEMENT) COMPACTED IN 200mm THICK LAYERS TO 98% MMDD TO UNDERSIDE OF PAVEMENT.

BACKFILL ALL TRENCHES NOT UNDER ROADS, PAVEMENTS, PATHS AND BUILDINGS WITH APPROVED EXCAVATED OR IMPORTED MATERIAL COMPACTED TO 95% SMDD.

STORMWATER DRAINAGE

- ALL PIPES SHALL BE CLASS 2 RUBBER-RING JOINTED RCP U.N.O. WHERE UPVC PIPES HAVE BEEN SPECIFIED. THE FOLLOWING CLASS PIPEWORK IS TO BE ADOPTED U.N.O. Ø100mm OR LESS TO BE CLASS 'SN10' AND ABOVE Ø100mm TO BE CLASS 'SN8'. CLASS 4 PIPES ARE TO BE USED WHERE COVER OVER THE PIPE IS BELOW 600mm AND BENEATH A TRAFFICABLE PAVEMENT.
- 2. uPVC STORMWATER LINES PASSING UNDER FLOOR SLABS TO BE CONCRETE ENCASED.
- FRC PIPES EQUAL TO THAT OF THE STEEL REINFORCED CONCRETE PIPE CLASS SPECIFIED ON THE DRAWINGS MAY BE USED SUBJECT TO APPROVAL FROM THE SUPERINTENDENT.
- 4. ALL PIPE ARE TO BE LAID AT 1.0% MIN GRADE U.N.O.
- 5.1. USE HOT DIPPED GALVANISED COVERS AND GRATES COMPLYING
- WITH RELEVANT COUNCIL AND AUSTRALIAN STANDARDS. 5.2. ALL COVERS AND GRATES TO BE POSITIONED IN A FRAME AND MANUFACTURED AS A UNIT
- 5.3. ALL COVERS AND GRATES TO BE FITTING WITH POSITIVE COVER LIFTING KEYS
- 5.4. OBTAIN SUPERINTENDENTS APPROVAL FOR THE USE OF CAST IRON SOLID COVERS AND GRATES. CAST IRON SOLID COVERS (IF APPROVED) TO CONSIST OF CROSS-WEBBED CELLULAR CONSTRUCTION WITH THE RIBS UPPERMOST TO ALLOW INFILLING WITH CONCRETE. INSTALL POSITIVE COVER LIFTING KEYS AND PLASTIC PLUGS.
- 5.5. UNLESS DETAILED OR SPECIFIED OTHERWISE, COVERS AND GRATES TO BE CLASS 'D' IN VEHICULAR PAVEMENTS AND CLASS 'B' ELSEWHERE.
- 5.6. ALL GRATED TRENCH DRAINS SHOULD BE 'CLASS D' CAST IRON WITHIN VEHICULAR PAVEMENTS AND CLASS 'B' HEEL SAFE WITHIN PEDESTRIAN PAVEMENTS.
- 6. ALL PIPE BENDS. JUNCTIONS, ETC ARE TO BE PROVIDED USING PURPOSE MADE FITTINGS OR STORMWATER PITS.
- ALL CONNECTIONS TO EXISTING DRAINAGE STRUCTURES SHALL BE MADE IN A TRADESMAN-LIKE MANNER AND CEMENT RENDERED TO ENSURE A SMOOTH FINISH.
- 7. ENSURE PIPEWORK DOES NOT PROTRUDE BEYOND THE INSIDE FACE OF THE PIT WALL. PIPEWORK IS TO FINISH FLUSH WITH INTERNAL WALL (UNLESS OTHERWISE NOTED OR DETAILED). CONNECTION TO BE RENDERED AND MADE NEAT ON THE INSIDE FACE OF THE PIT
- THE CONTRACTOR SHALL SUPPLY AND INSTALL ALL FITTINGS AND SPECIALS INCLUDING VARIOUS PIPE ADAPTORS TO ENSURE PROPER CONNECTION BETWEEN DISSIMILAR PIPEWORK.
- 9. U.N.O. MATERIAL USED FOR BEDDING OF PIPES SHALL BE APPROVED NON-COHESIVE GRANULAR MATERIAL HAVING HIGH PERMEABILITY AND HIGH STABILITY WHEN SATURATED AND FREE OF ORGANIC AND CLAY MATERIAL
- 10. BEDDING SHALL BE U.N.O TYPE HS2 UNDER ROADS AND H2 UNDER GENERAL AREAS IN ACCORDANCE WITH CURRENT RELEVANT INDUSTRY STANDARDS AND GUIDELINES.
- 11. THE CONTRACTOR SHALL ENSURE AND PROTECT THE INTEGRITY OF ALL STORMWATER PIPES DURING CONSTRUCTION. ANY AND ALL DAMAGE TO THESE PIPES AS A RESULT OF THESE WORKS SHALL BE REPAIRED BY THE CONTRACTOR UNDER THE DIRECTION OF THE SUPERINTENDENT AND AT NO EXTRA COST TO THE CONTRACT
- 12. NOTE THAT THE PIT COVER LEVEL NOMINATED IN GUTTERS ARE TO THE INVERT OF THE GUTTER WHICH ARE 40mm I OWER THAN THE PAVEMENT LEVEL AT LIP OF GUTTER. REFER KERB DETAILS FOR CONFIRMATION.

SUBSOIL DRAINAGE

- 13. ϕ 100mm SUBSOIL DRAINAGE LINES WITH NON-WOVEN GEOTEXTILE FILTER SOCK SURROUND SHALL BE CONNECTED TO A STORMWATER DRAINAGE PIT (AT MIN 1% LONGITUDINAL GRADE) AND PROVIDED IN THE FOLLOWING LOCATIONS: 13.1. THE HIGH SIDE OF PROPOSED TRAFFICKED PAVEMENT AREAS. 13.2. ALL PLANTER AND TREE BEDS PROPOSED ADJACENT TO
- PAVEMENT AREAS. 13.3. BEHIND RETAINING WALLS (IN ACCORDANCE WITH RETAINING
- WALL DETAILS).
- 13.4. UPSTREAM OF STORMWATER PITS 13.5. BENEATH FLEXIBLE PAVEMENT ALONG A SAG PROFILE
- 13.6. ALL OTHER AREAS SHOWN ON DRAWINGS. 13.7. CONTRACTOR IS TO MAKE ALLOWANCE IN BOTH TENDER AND CONSTRUCTION COSTING TO ALLOW FOR SUBSURFACE DRAINAGE BEHIND ALL RETAINING WALLS / ABOVE LOCATIONS AND TO
- 14. WHERE SUBSOIL DRAINAGE PASSES BENEATH BUILDINGS / PAVED AREAS AND/OR PAVEMENTS. CONTRACTOR TO ENSURE Ø100mm CLASS 'SN10' uPVC DRAINAGE LINE IS USED AND THAT PROPRIETARY FITTINGS ARE USED TO RECONNECT SUBSOIL DRAINAGE LINE.

MAKE CONNECTION TO STORMWATER SYSTEM.

- 15. THE CONTRACTOR SHALL INSTALL INSPECTION OPENINGS / CLEAROUTS TO ALL SUBSOIL DRAINAGE LINES AND DOWNPIPE LINES AS SPECIFIED ON DRAWINGS AND IN ACCORDANCE WITH COUNCIL SPECIFICATIONS. HOWEVER AS A MINIMUM THEY ARE TO BE PLACED AT MAXIMUM 30m CENTRES AND AT ALL UPSTREAM ENDPOINTS.
- 16. PROVIDE 3.0m LENGTH OF \$\phi\$100 SUBSOIL DRAINAGE LINE WRAPPED IN NON-WOVEN GEOTEXTILE FILTER FABRIC TO THE UPSTREAM SIDE OF STORMWATER PITS, LAID IN STORMWATER PIPE TRENCHES AND CONNECTED TO DRAINAGE PIT.
- 17. IN AREAS WHERE DUMPED / HAND PLACED ROCK IS USED AS A MEANS OF SCOUR PROTECTION, CONTRACTOR IS TO EXCAVATE A MINIMUM OF 100mm FROM PROPOSED SURFACE, LEVEL AND COMPACT SUBGRADE AS SPECIFIED. ROCK TO THEN BE PLACED ON GEOTEXTILE FILTER FABRIC A34.
- 18. THE CONTRACTR IS TO ENSURE THAT A MINIMUM 150mm CLEARANCE IS PROVIDED BETWEEN THE INTERNAL FACE OF PIPE AND ADJACENT INTERNAL PIT WALLS
- 19. WHERE TRENCHES ARE IN ROCK, THE PIPE SHALL BE BEDDED ON A MIN 50mm CONCRETE BED (OR 75mm THICK BED OF 12mm BLUE METAL) UNDER THE BARREL OF THE PIPE. THE PIPE COLLAR AT NO POINT SHALL BEAR ON THE ROCK. (E.G. CLEAN 5-12mm AGGREGATE)

PRECAST STORMWATER PITS

- THE USE OF PRE-CAST STORMWATER DRAINAGE PITS IS NOT ACCEPTED WITHOUT CONFIRMATION BETWEEN NORTHROP ENGINEERS AND THE CONTRACTOR REGARDING QUALITY CONTROL AND CERTIFICATION OF FINISHES.
- REFER MANUFACTURERS SPECIFICATIONS FOR INSTALLATION GUIDELINES.
- PRECAST PIT TO BE PLACED ON MINIMUM 150mm THICK CONCRETE PAD AND BED MINIMUM 50mm WHILST CONCRETE IS STILL PARTIALLY WET.
- 4. ENSURE PENETRATION IS CORED THROUGH PIT FACE TO ALLOW CONNECTION AND IS NOT OVERSIZED.
- ENSURE A SEALED FINISH AT PIPE CONNECTIONS BY HAND-APPLYING MINIMUM 150mm THICK CONCRETE AROUND PIPE AT THE EXTERNAL FACE OF THE PIT. ENSURE CONCRETE DOES NOT AFFECT THE INTEGRITY OF THE SUBSOIL DRAINAGE CONNECTED TO THE PIT.
- ENSURE A SMOOTH SEALED FINISH AT PIPE CONNECTIONS BY HAND APPLYING CONCRETE AROUND THE PIPE ON THE INTERNAL FACE OF THE PIT TO FILL IN ANY VOIDS CREATED WHEN PENETRATION FOR THE PIPE WAS CORED.
- ENSURE PIPEWORK DOES NOT PROTRUDE BEYOND THE INSIDE FACE OF THE PIT WALL. PIPEWORK IS TO FINISH FLUSH WITH INTERNAL WALL (UNLESS OTHERWISE NOTED OR DETAILED). CONNECTION TO BE RENDERED AND MADE NEAT ON THE INSIDE FACE OF THE PIT.
- 8. ENSURE THE OUTLET PIPE IS CONNECTED AT THE INVERT LEVEL OF THE PIT TO DRAIN. ALTERNATIVELY FILL THE BASE OF THE PIT WITH MASS CONCRETE (MIN 50mm THICK) OR APPROVED GROUTING COMPOUND (LESS THAN 50mm THICK) TO DRAIN.
- PROVIDE CONCRETE BENCHING TO SIDES OF PIT TO SUIT PIPE DIAMETER. HEIGHT TO MATCH MINIMUM 1/3 PIPE DIAMETER.

ALL STORMWATER MANAGEMENT MEASURES SHOWN ON THIS DRAWING HAVE BEEN PREPARED FOR DEVELOPMENT APPLICATION PURPOSES TO DEMONSTRATE FEASIBILITY. ALL MEASURES WILL BE SUBJECT TO DETAIL DESIGN AT THE CONSTRUCTION CERTIFICATE STAGE AND MAY BE SUBJECT TO VARIATION PROVIDED THAT THE DESIGN INTENT IS MAINTAINED.

> DIAL BEFORE YOU DIG

NOT FOR CONSTRUCTION

CIVIL DOCUMENTATION

192734 DRAWING NUMBER REVISION

DRAWING NOT TO BE USED FOR CONSTRUCTION UNLESS THE COPYRIGHT OF THIS DRAWING REMAINS WITH VERIFICATION SIGNATURE HAS BEEN ADDED NORTHROP CONSULTING ENGINEERS PTY LTD

ARCHITECT

NORTHROP ACCEPTS NO RESPONSIBILITY FOR THE ISABILITY, COMPLETENESS OR SCALE OF DRAWINGS TRANSFERRED ELECTRONICALLY THIS DRAWING MAY HAVE BEEN PREPARED USING COLOUR. AND MAY BE INCOMPLETE IF COPIED TO BLACK & WHITE

LL DIMENSIONS TO BE VERIFIED ON SITE BEFORE

Level 11 345 George Street, Sydney NSW 2000 Ph (02) 9241 4188 Fax (02) 9241 4324

Email sydney@northrop.com.au ABN 81 094 433 100


CARPARK


WESTMEAD CATHOLIC COMMUNITY

DARCY ROAD, WESTMEAD

SPECIFICATION NOTES

DAC101.1 DRAWING SHEET SIZE = A1

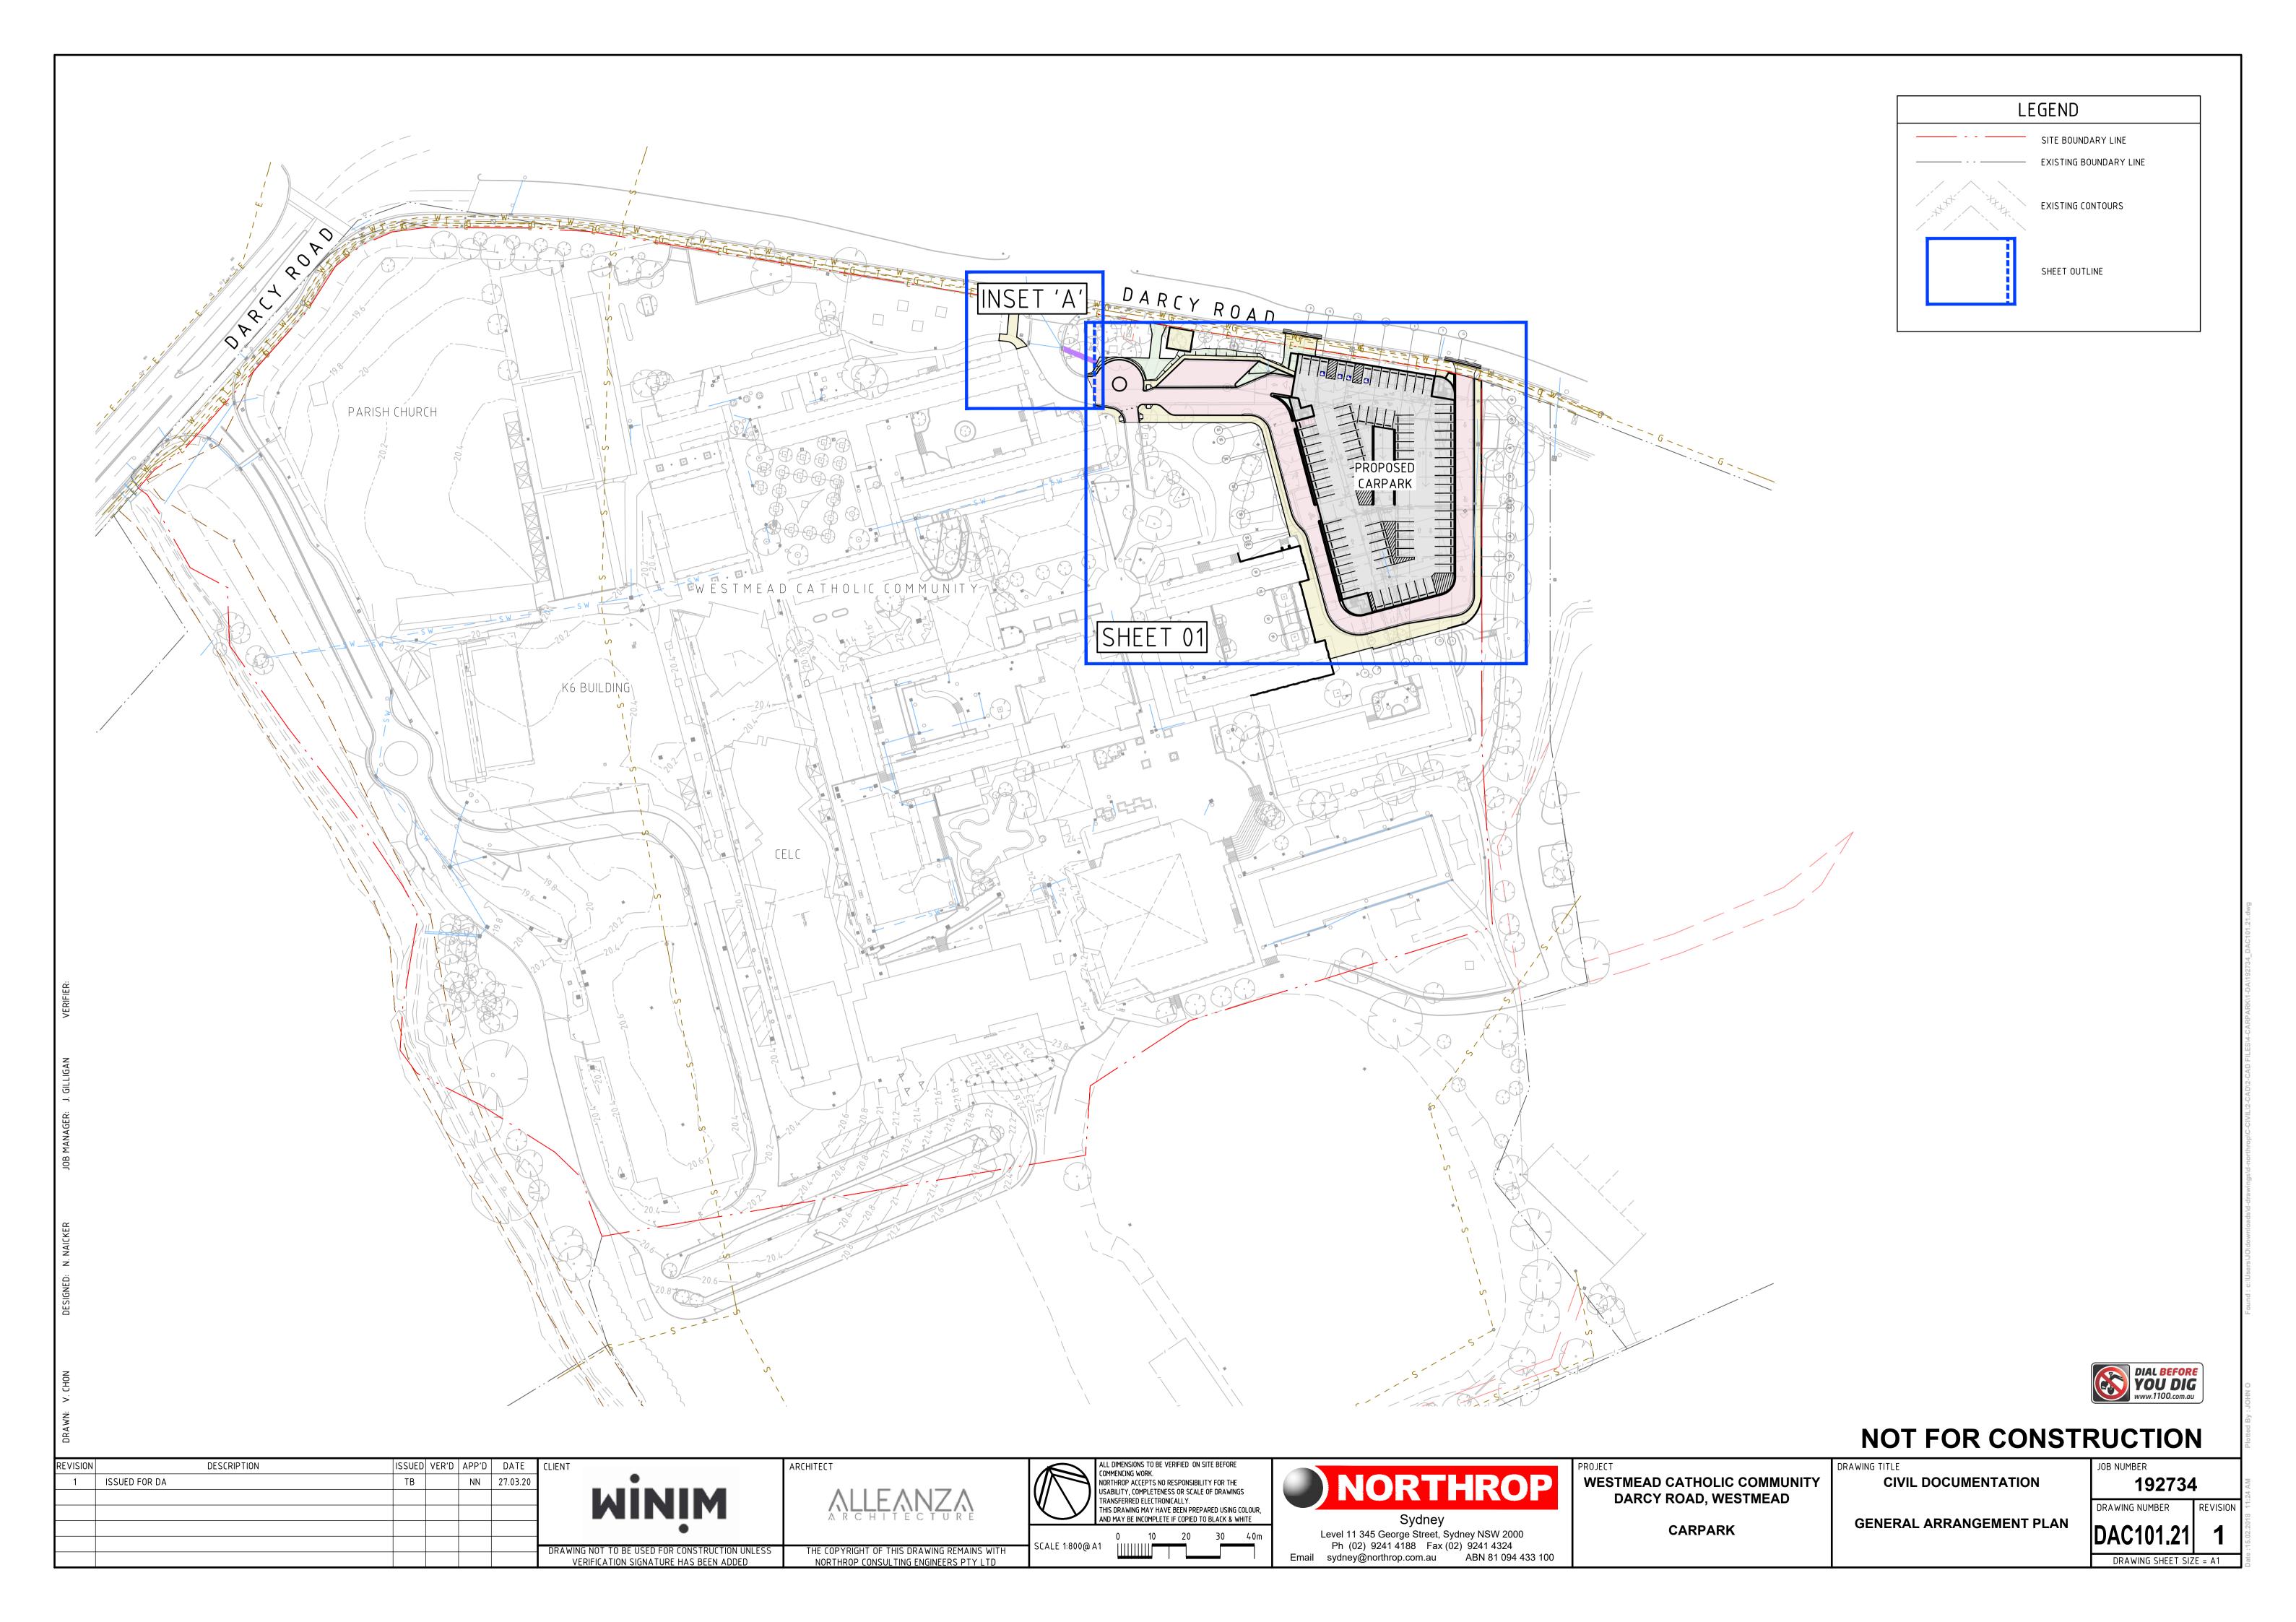


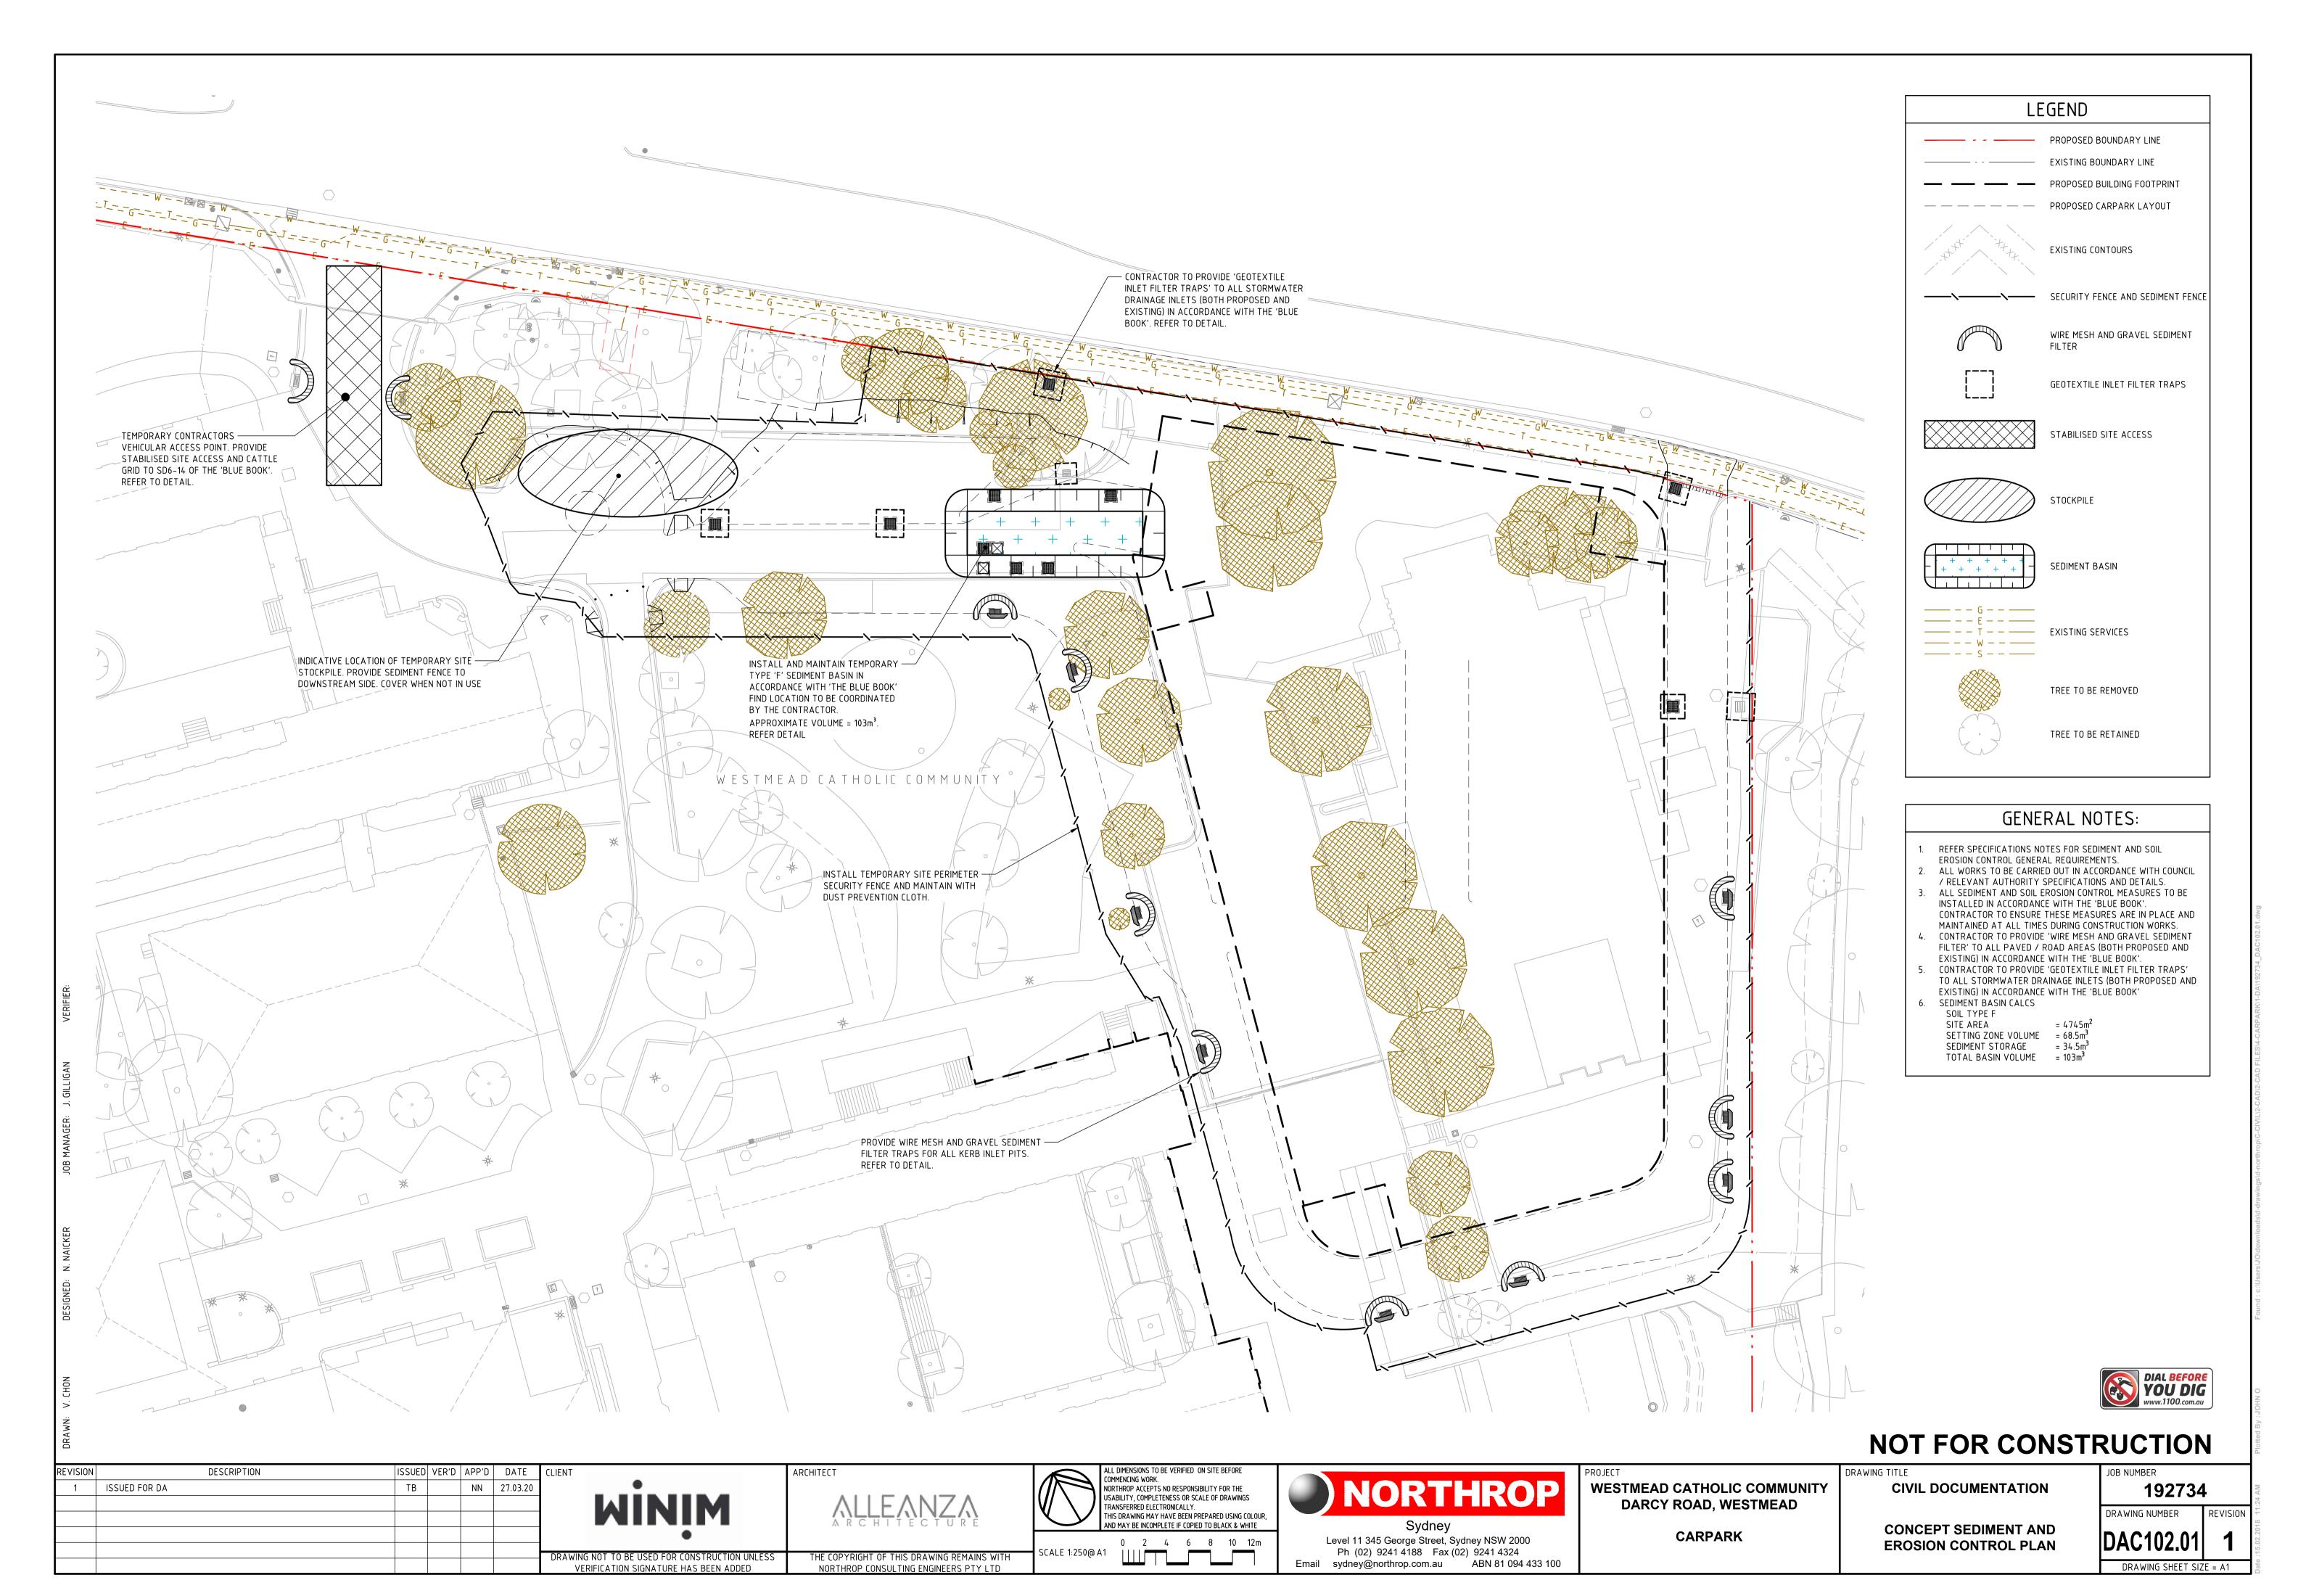




- 1. PLACE STOCKPILES MORE THAN 2m (PREFERABLY 5m) FROM EXISTING VEGETATION, CONCENTRATED WATER FLOW, ROADS AND HAZARD AREAS.
- 2. CONSTRUCT ON THE CONTOUR AS LOW, FLAT, ELONGATED MOUNDS.
- 3. WHERE THERE IS SUFFICIENT AREA, TOPSOIL STOCKPILES SHALL BE LESS THAN 2m IN HEIGHT.
- 4. WHERE THEY ARE TO BE IN PLACE FOR MORE THAN 10 DAYS, STABILISE FOLLOWING THE APPROVED ESCP
- OR SWMP TO REDUCE THE C-FACTOR TO LESS THAN 0.10. 5. CONSTRUCT EARTH BANKS (STANDARD DRAWING 5-5) ON THE UPSLOPE SIDE TO DIVERT WATER AROUND
- STOCKPILES AND SEDIMENT FENCES (STANDARD DRAWING 6-8) 1 TO 2m DOWNSLOPE.

STOCKPILE

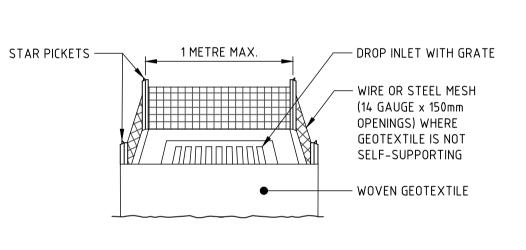

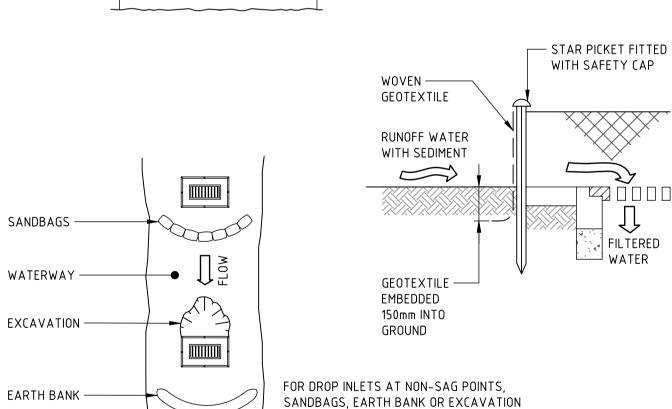

CONSTRUCTION NOTES


REVISION

- 1. FABRICATE A SEDIMENT BARRIER MADE FROM GEOTEXTILE OR STRAW BALES.
- 2. FOLLOW STANDARD DRAWING 6-7 AND STANDARD DRAWING 6-8 FOR INSTALLATION PROCEDURES FOR THE STRAW BALES OR GEOFABRIC. REDUCE THE PICKET SPACING TO 1 METRE CENTRES.

USED TO CREATE ARTIFICIAL SAG POINT

- 3. IN WATERWAYS, ARTIFICIAL SAG POINTS CAN BE CREATED WITH SANDBAGS OR EARTH BANKS AS SHOWN IN
- 4. DO NOT COVER THE INLET WITH GEOTEXTILE UNLESS THE DESIGN IS ADEQUATE TO ALLOW FOR ALL WATERS TO BYPASS IT.

GEOTEXTILE INLET FILTER TRAPS

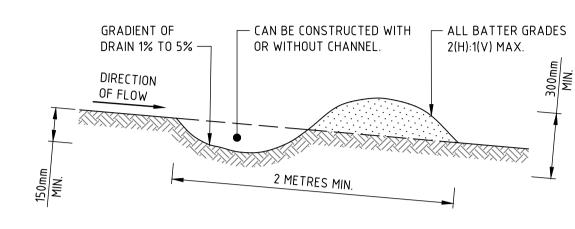

CONSTRUCTION NOTES

1. BUILD WITH GRADIENTS BETWEEN 1 AND 5 PERCENT.

CONSTRUCTION NOTES

VERIFICATION SIGNATURE HAS BEEN ADDED

AT THE SAME LEVEL AS THE TOP OF THE KERB.

2. LAY 1.4m LONG TURF STRIPS NORMAL TO THE KERB EVERY 10m.

INSTALL A 400mm MINIMUM WIDE ROLL OF TURF ON THE FOOTPATH NEXT TO THE KERB AND


3. REHABILITATE DISTURBED SOIL BEHIND THE TURF STRIP FOLLOWING THE ESCP/SWMP.

KERBSIDE TURF STRIP

NORTHROP CONSULTING ENGINEERS PTY LTD

- 2. AVOID REMOVING TREES AND SHRUBS IF POSSIBLE WORK AROUND THEM.
- 3. ENSURE THE STRUCTURES ARE FREE OF PROJECTIONS OR OTHER IRREGULARITIES THAT COULD IMPEDE WATER FLOW.
- 4. BUILD THE DRAINS WITH CIRCULAR, PARABOLIC OR TRAPEZOIDAL CROSS SECTIONS, NOT V SHAPED.
- 5. ENSURE THE BANKS ARE PROPERLY COMPACTED TO PREVENT FAILURE.
- 6. COMPLETE PERMANENT OR TEMPORARY STABILISATION WITHIN 10 DAYS OF CONSTRUCTION.


NOTE: ONLY TO BE USED AS TEMPORARY BANK WHERE MAXIMUM UPSLOPE LENGTH IS 80 METRES. DRAINAGE SWALE - LOW FLOW

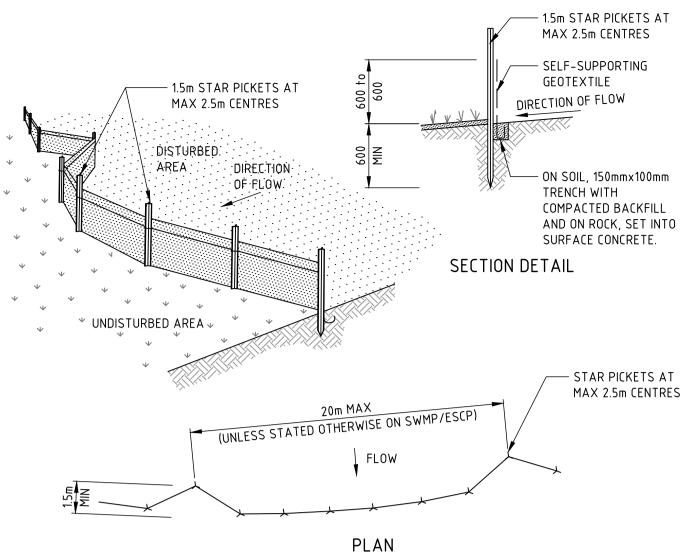

CONSTRUCTION NOTES


- 1. CONSTRUCT SEDIMENT FENCES AS CLOSE AS POSSIBLE TO BEING PARALLEL TO THE CONTOURS OF THE SITE, BUT WITH SMALL RETURNS AS SHOWN IN THE DRAWING TO LIMIT THE CATCHMENT AREA OF ANY ONE SECTION. THE CATCHMENT AREA SHOULD BE SMALL ENOUGH TO LIMIT WATER FLOW IF CONCENTRATED AT ONE POINT TO 50 LITRES PER SECOND IN THE DESIGN STORM EVENT, USUALLY THE 10-YEAR EVENT.
- 2. CUT A 150mm DEEP TRENCH ALONG THE UPSLOPE LINE OF THE FENCE FOR THE BOTTOM OF THE FABRIC TO BE ENTRENCHED.
- 3. DRIVE 1.5 METRE LONG STAR PICKETS INTO GROUND AT 2.5 METRE INTERVALS (MAX) AT THE DOWNSLOPE EDGE OF THE TRENCH. ENSURE ANY STAR PICKETS ARE FITTED WITH SAFETY CAPS.
- 4. FIX SELF-SUPPORTING GEOTEXTILE TO THE UPSLOPE SIDE OF THE POSTS ENSURING IT GOES TO THE BASE OF THE TRENCH. FIX THE GEOTEXTILE WITH WIRE TIES OR AS RECOMMENDED BY THE MANUFACTURER. ONLY USE GEOTEXTILE SPECIFICALLY PRODUCED FOR SEDIMENT FENCING. THE USE OF SHADE CLOTH FOR THIS PURPOSE IS
- 5. JOIN SECTIONS OF FABRIC AT A SUPPORT POST WITH A 150mm OVERLAP.
- 6. BACKFILL THE TRENCH OVER THE BASE OF THE FABRIC AND COMPACT IT THOROUGHLY OVER THE GEOTEXTILE.

SEDIMENT FENCE

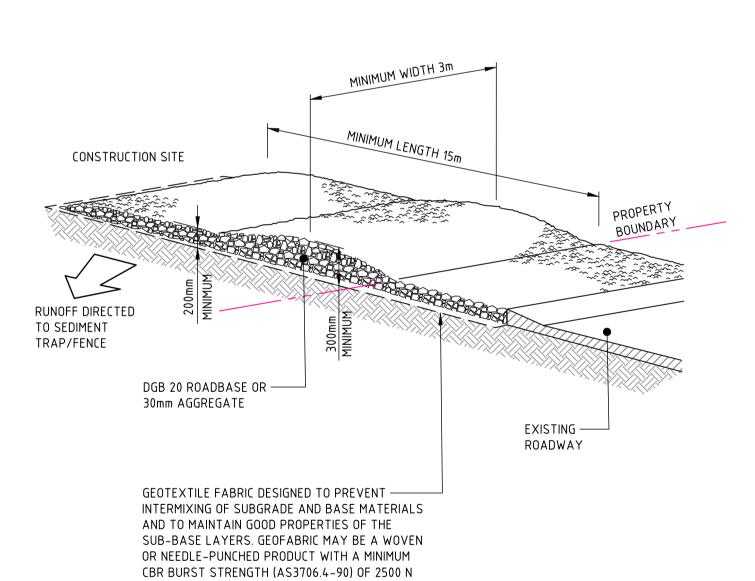

- I. STRIP THE TOPSOIL, LEVEL THE SITE AND COMPACT THE SUBGRADE.
- 2. COVER THE AREA WITH NEEDLE-PUNCHED GEOTEXTILE.
- 3. CONSTRUCT A 200mm THICK PAD OVER THE GEOTEXTILE USING ROAD BASE OR 30mm AGGREGATE.

STABILISED SITE ACCESS

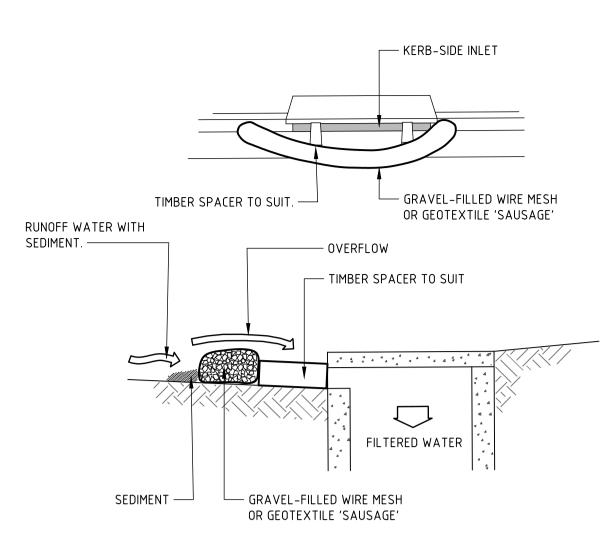

NOTE: THIS PRACTICE ONLY TO BE USED WHERE SPECIFIED IN APPROVED SWMP/ESCP.

CONSTRUCTION NOTES

- INSTALL FILTERS TO KERB INLETS ONLY AT SAG POINTS.
- 2. FABRICATE A SLEEVE MADE FROM GEOTEXTILE OR WIRE MESH LONGER THAN THE LENGTH OF THE INLET PIT AND FILL IT WITH 25mm TO 50mm GRAVEL.
- 3. FORM AN ELLIPTICAL CROSS-SECTION ABOUT 150mm HIGH x 400mm WIDE.
- 4. PLACE THE FILTER AT THE OPENING LEAVING AT LEAST A 100mm SPACE BETWEEN IT AND THE KERB INLET. MAINTAIN THE OPENING WITH SPACER BLOCKS.
- 5. FORM A SEAL WITH THE KERB TO PREVENT SEDIMENT BYPASSING THE FILTER.
- 6. SANDBAGS FILLED WITH GRAVEL CAN SUBSTITUTE FOR THE MESH OR GEOTEXTILE PROVIDING THEY ARE PLACED SO THAT THEY FIRMLY ABUT EACH OTHER AND SEDIMENT-LADEN WATERS CANNOT PASS BETWEEN.

WIRE MESH AND GRAVEL SEDIMENT FILTER

CONSTRUCTION NOTES

- 4. ENSURE THE STRUCTURE IS AT LEAST 15 METRES LONG OR TO BUILDING ALIGNMENT AND AT LEAST 3 METRES
- 5. WHERE A SEDIMENT FENCE JOINS ONTO THE STABILISED ACCESS, CONSTRUCT A HUMP IN THE STABILISED ACCESS TO DIVERT WATER TO THE SEDIMENT FENCE.



NOT FOR CONSTRUCTION

DESCRIPTION |ISSUED| VER'D | APP'D | DATE **WESTMEAD CATHOLIC COMMUNITY** NN 27.03.20 CIVIL DOCUMENTATION 1 ISSUED FOR DA NORTHROP ACCEPTS NO RESPONSIBILITY FOR THE USABILITY, COMPLETENESS OR SCALE OF DRAWINGS DARCY ROAD, WESTMEAD TRANSFERRED ELECTRONICALLY. THIS DRAWING MAY HAVE BEEN PREPARED USING COLOUR, AND MAY BE INCOMPLETE IF COPIED TO BLACK & WHITE


CARPARK Level 11 345 George Street, Sydney NSW 2000 **CONTROL DETAILS** Ph (02) 9241 4188 Fax (02) 9241 4324 Email sydney@northrop.com.au ABN 81 094 433 100


SEDIMENT AND EROSION

192734 DRAWING NUMBER

DAC102.1

DRAWING SHEET SIZE = A1

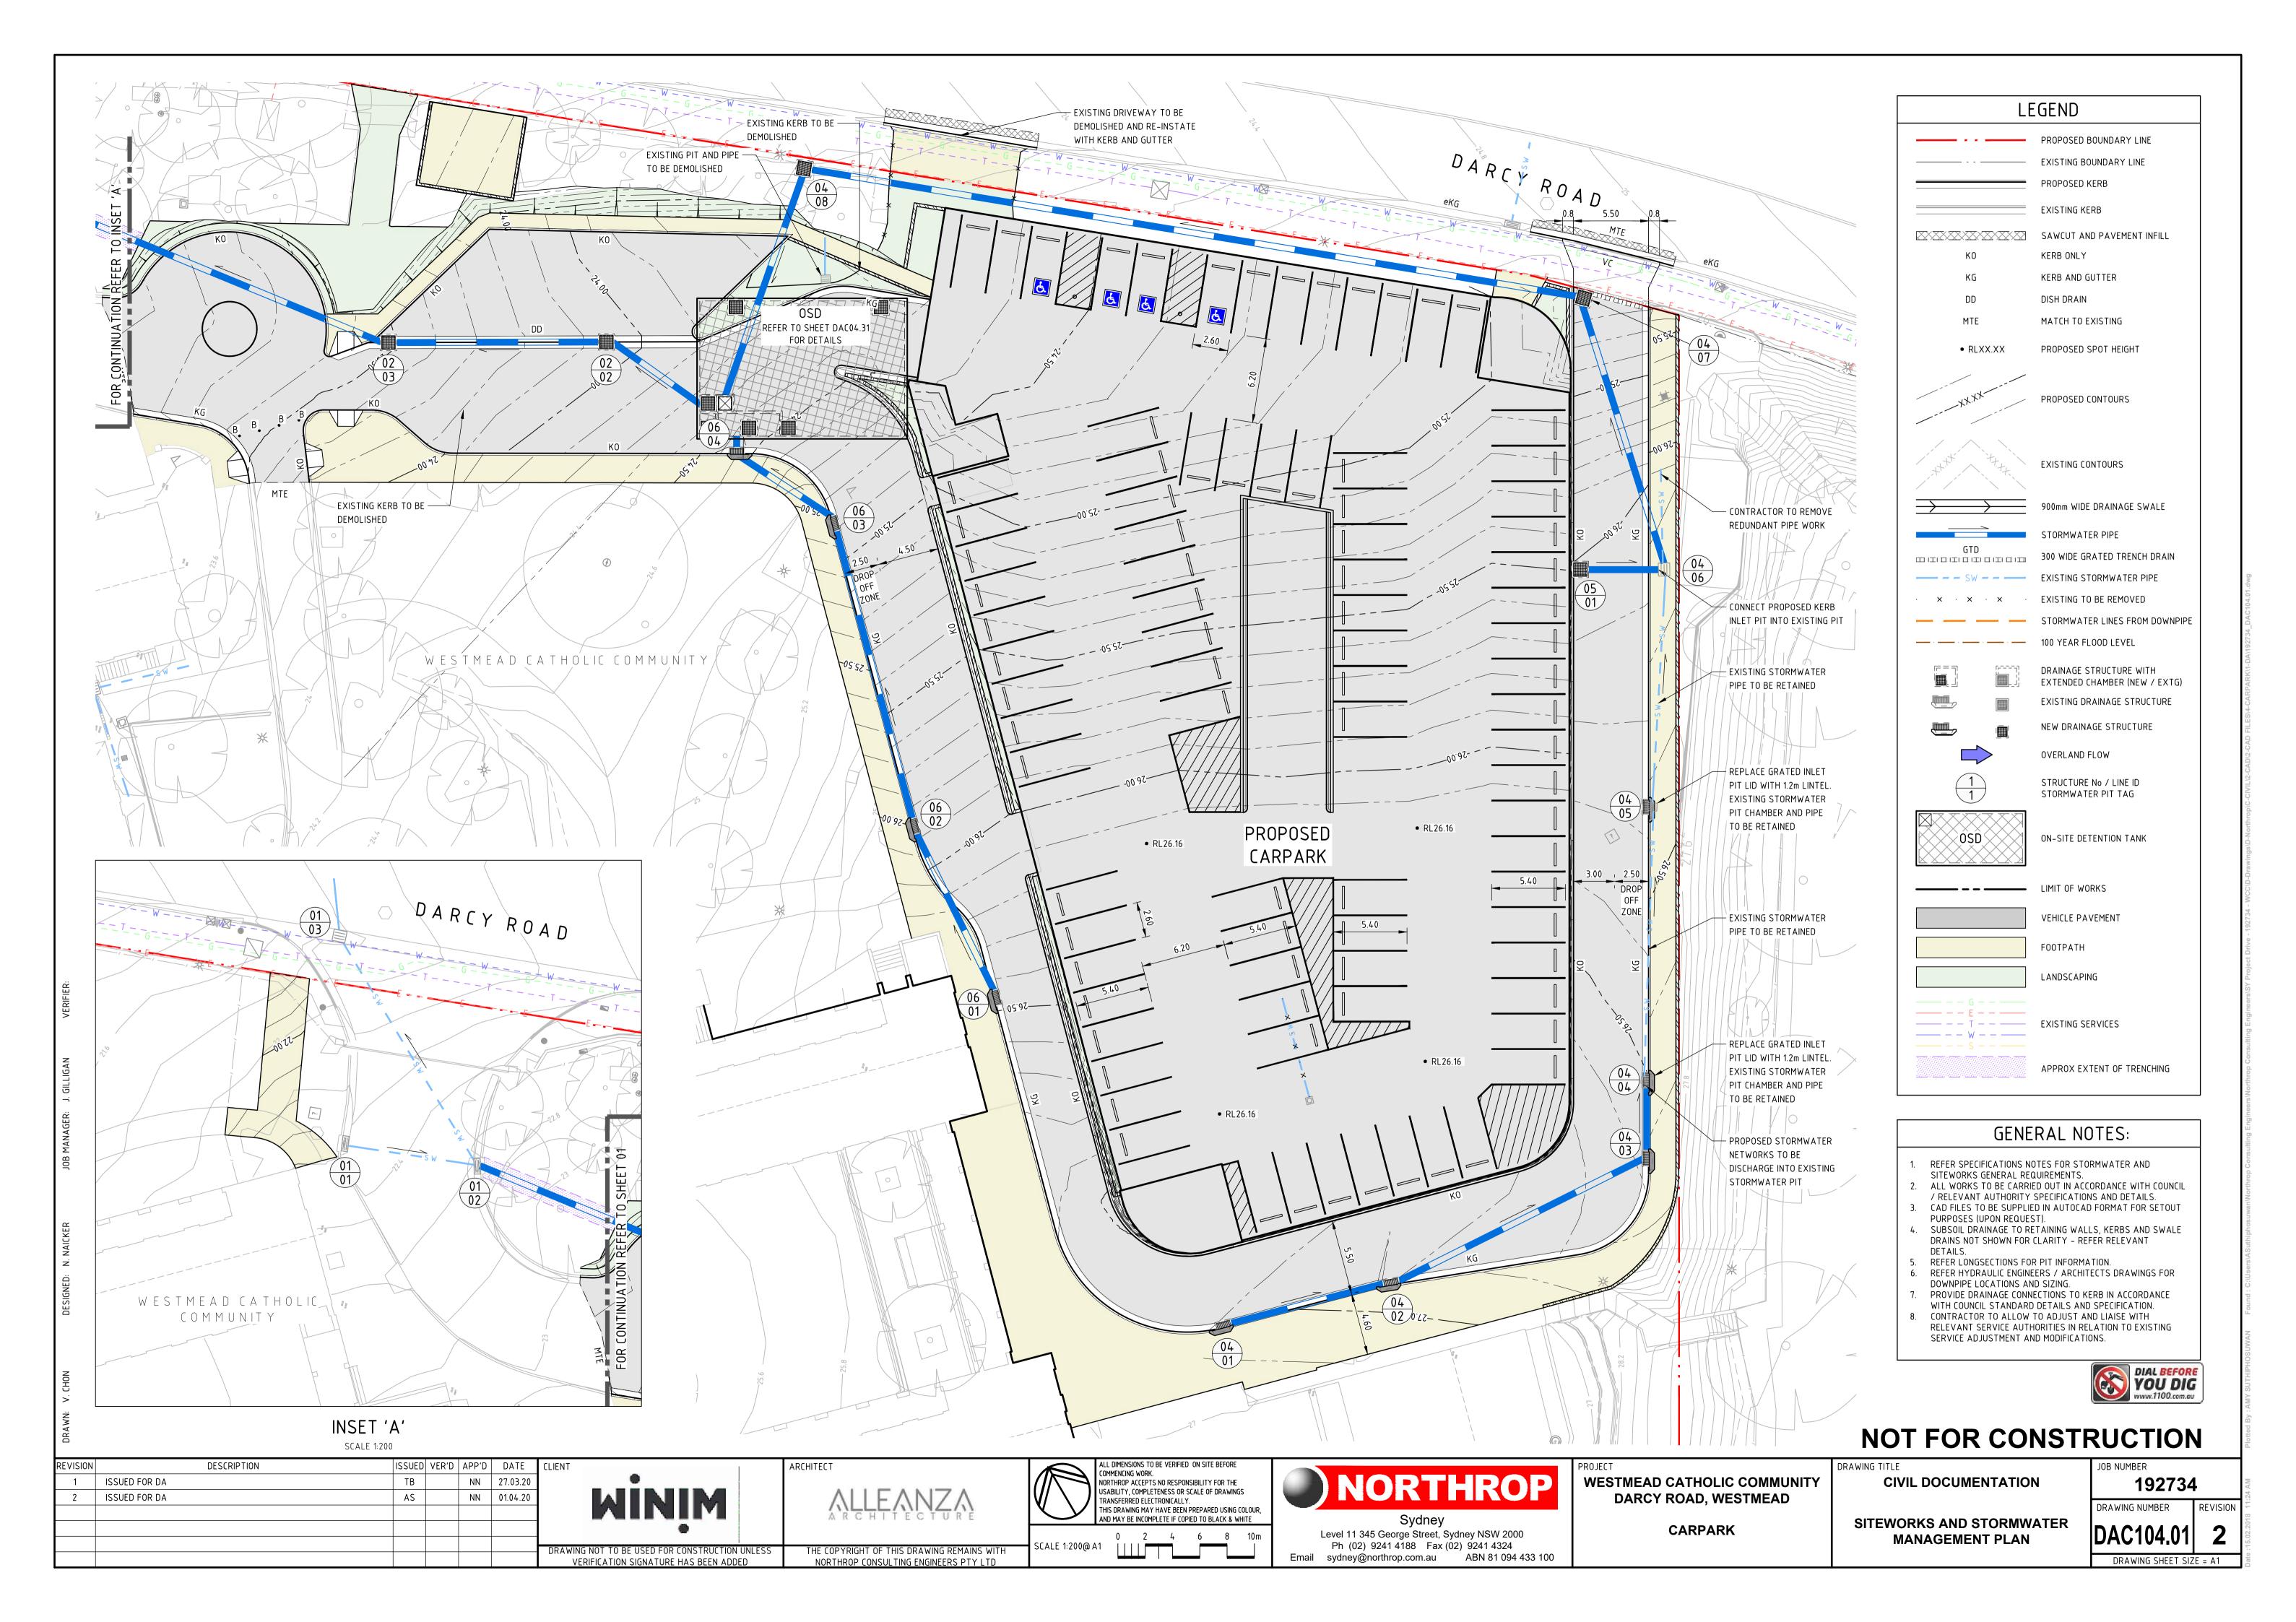

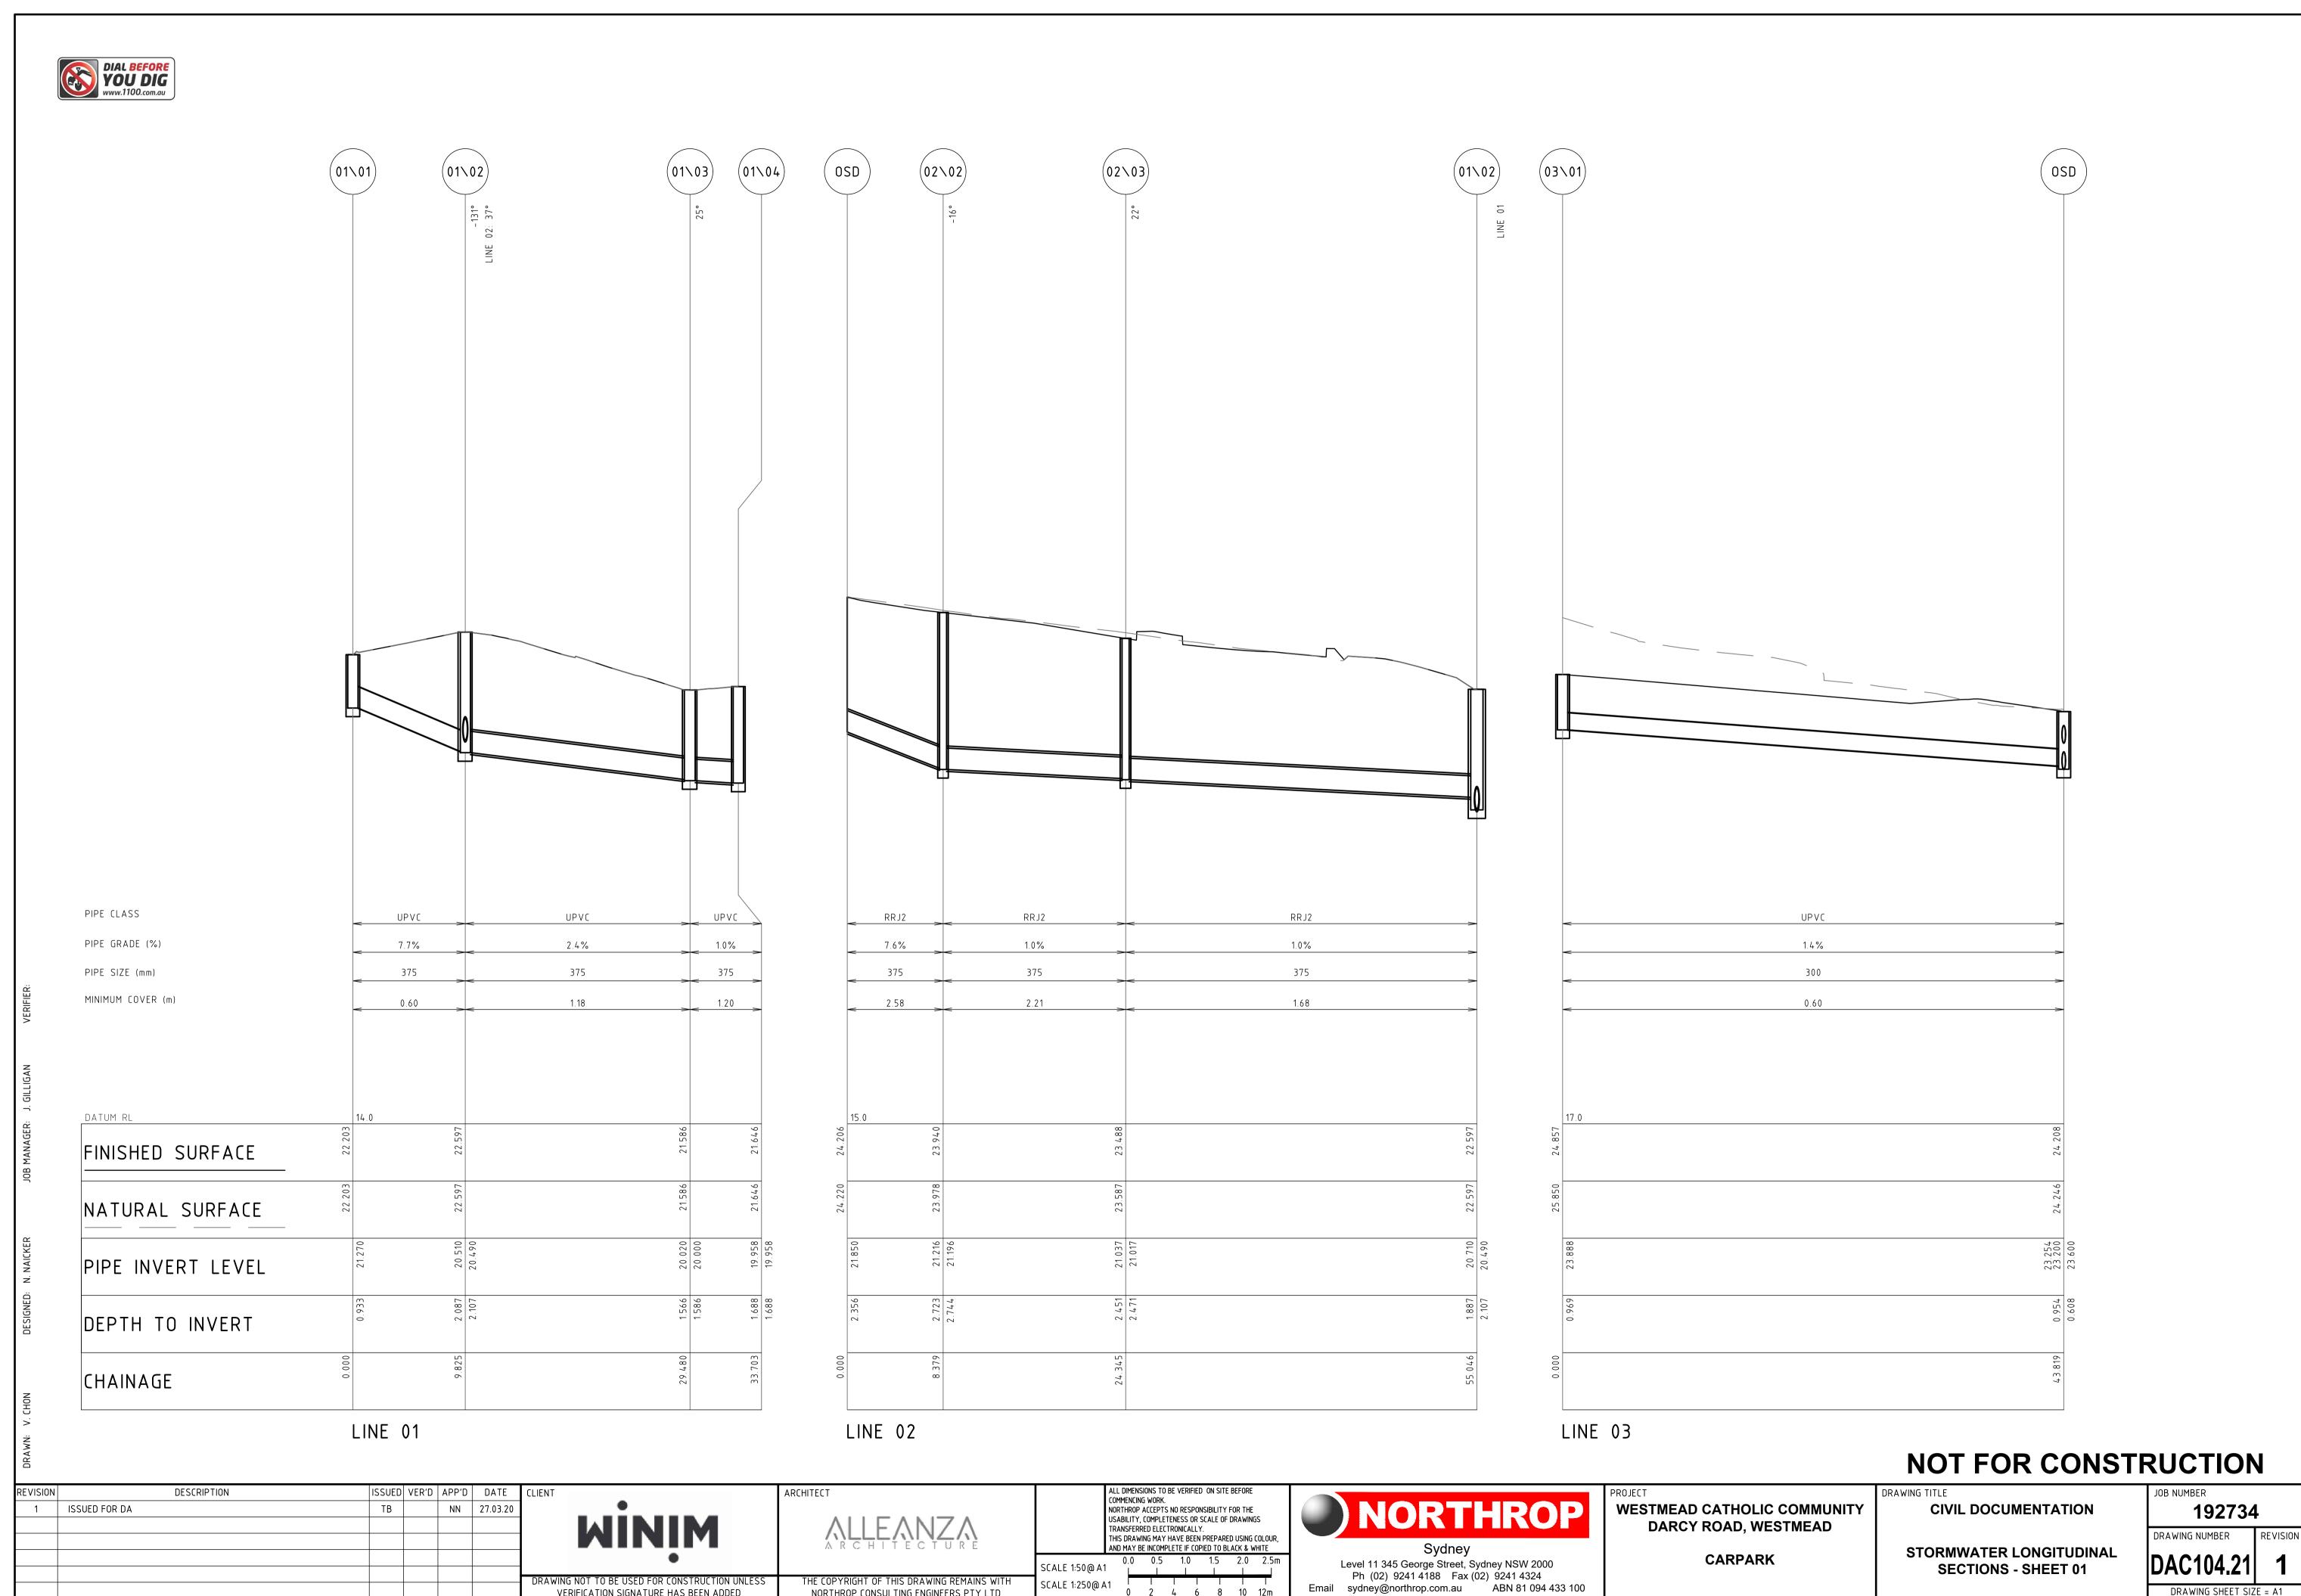


SCALE 1:50@ A1

SCALE 1:250@ A1


NORTHROP CONSULTING ENGINEERS PTY LTD

DRAWING NOT TO BE USED FOR CONSTRUCTION UNLESS
VERIFICATION SIGNATURE HAS BEEN ADDED

STORMWATER LONGITUDINAL DAC104.21 **SECTIONS - SHEET 01** DRAWING SHEET SIZE = A1

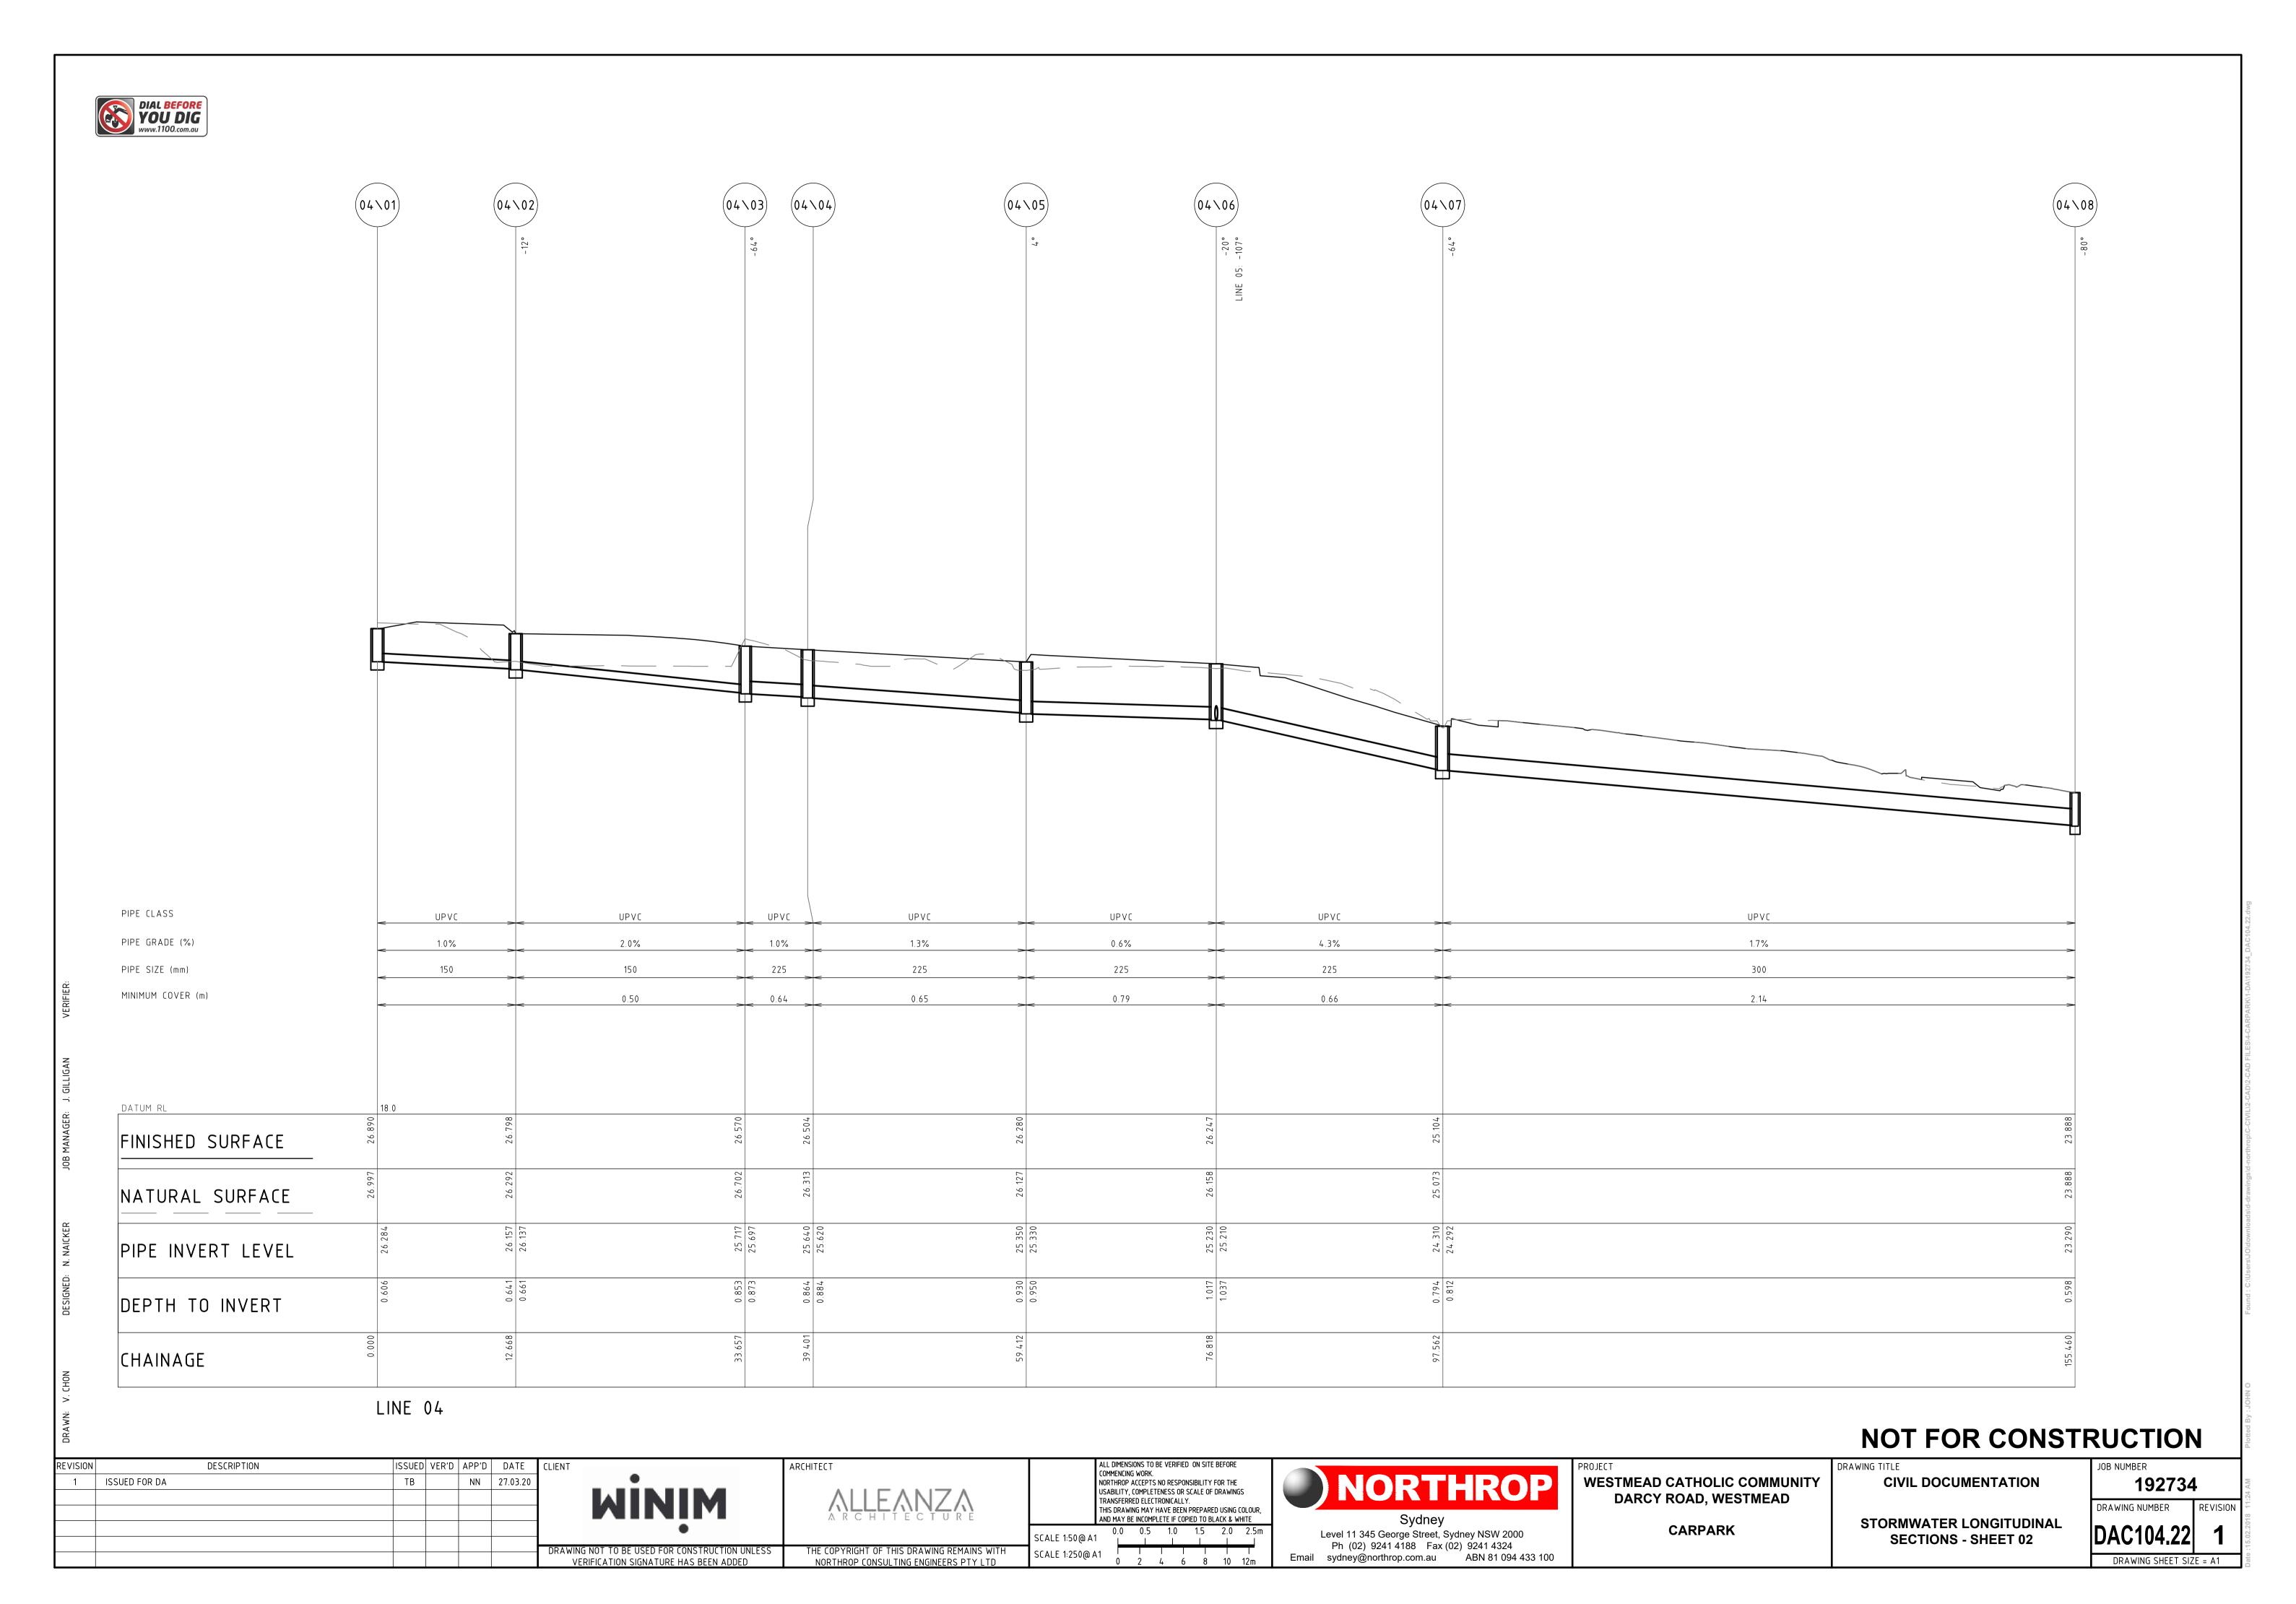



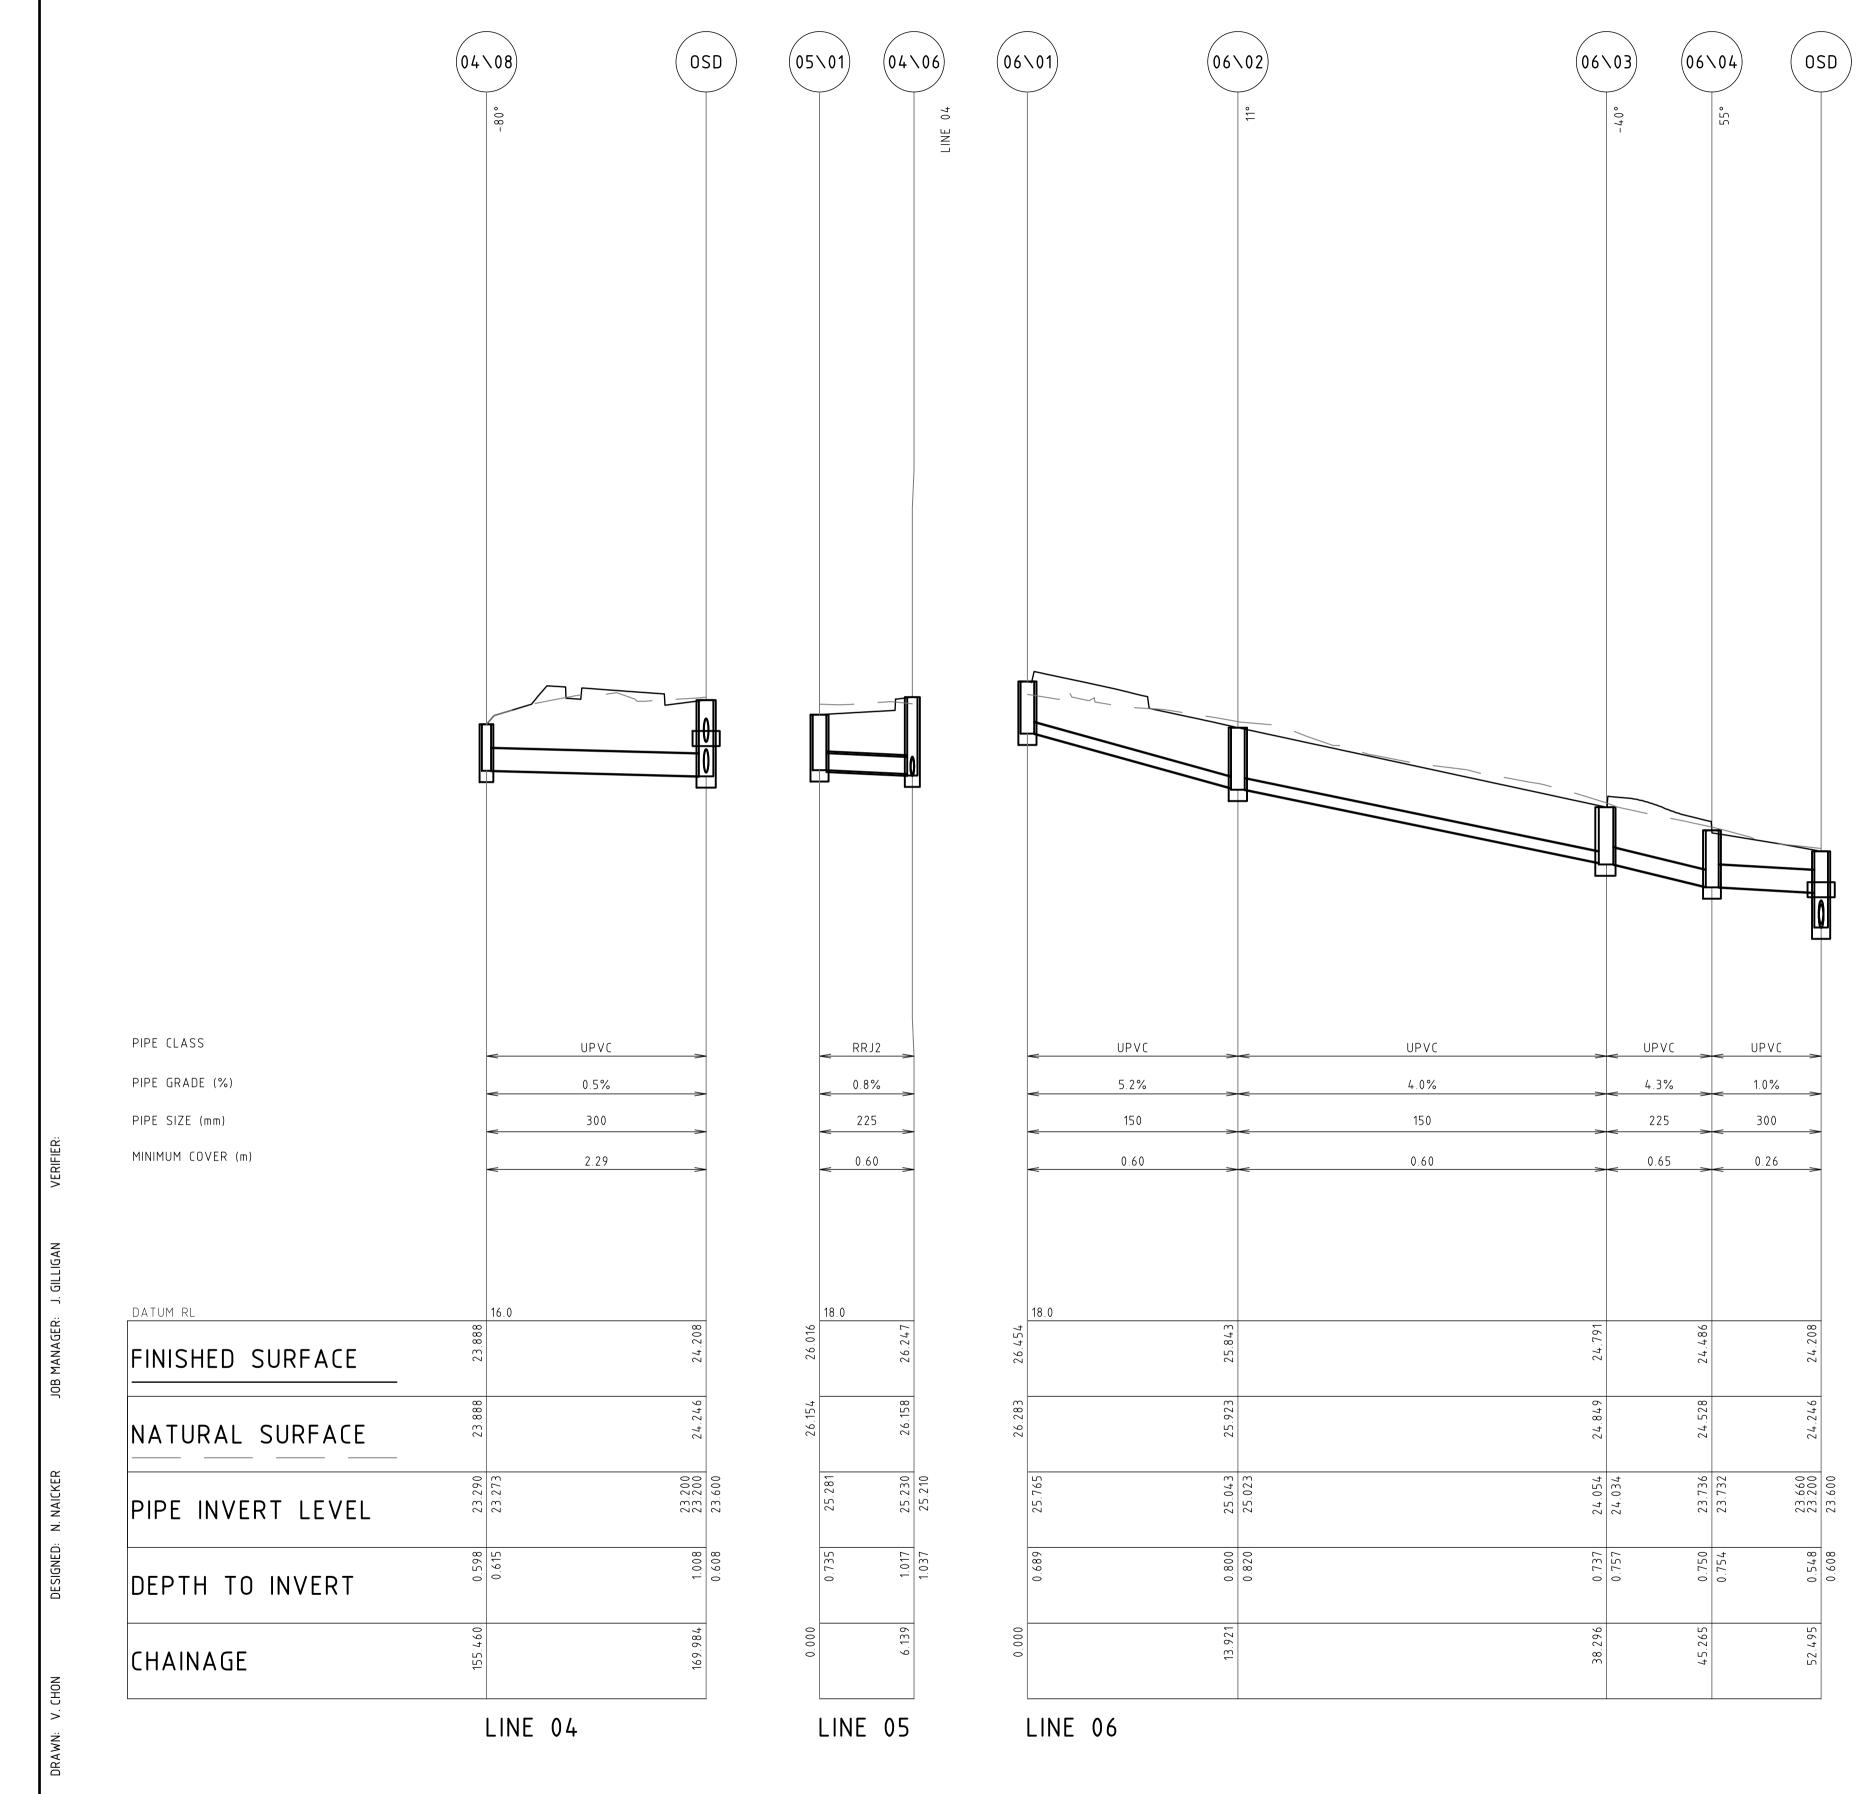

NOT FOR CONSTRUCTION

REVISION	DESCRIPTION	ISSUED	VER'D	APP'D	DATE	CLIENT
1	ISSUED FOR DA	ТВ		NN	27.03.21	
						DRAWIN
						DNAWIN

RAWING NOT TO BE USED FOR CONSTRUCTION UNIVERSIFICATION SIGNATURE HAS BEEN ADDED

ARCHITECT

ARCHITECT

ARCHITECTURE

NORTHROP CONSULTING ENGINEERS PTY LTD

ALL DIMENSIONS TO BE VERIFIED ON SITE BEFORE
COMMENCING WORK.
NORTHROP ACCEPTS NO RESPONSIBILITY FOR THE
USABILITY, COMPLETENESS OR SCALE OF DRAWINGS
TRANSFERRED ELECTRONICALLY.
THIS DRAWING MAY HAVE BEEN PREPARED USING COLOUR,
AND MAY BE INCOMPLETE IF COPIED TO BLACK & WHITE

SCALE 1:50 @ A1

SCALE 1:250 @ A1

SCALE 1:250 @ A1

O 2 6 8 10 12 m



Sydney

Level 11 345 George Street, Sydney NSW 2000
Ph (02) 9241 4188 Fax (02) 9241 4324
Email sydney@northrop.com.au ABN 81 094 433 100

WESTMEAD CATHOLIC COMMUNITY
DARCY ROAD, WESTMEAD

CARPARK


CIVIL DOCUMENTATION


STORMWATER LONGITUDINAL SECTIONS - SHEET 03

192734


DAC104.23 1

DRAWING SHEET SIZE = A1

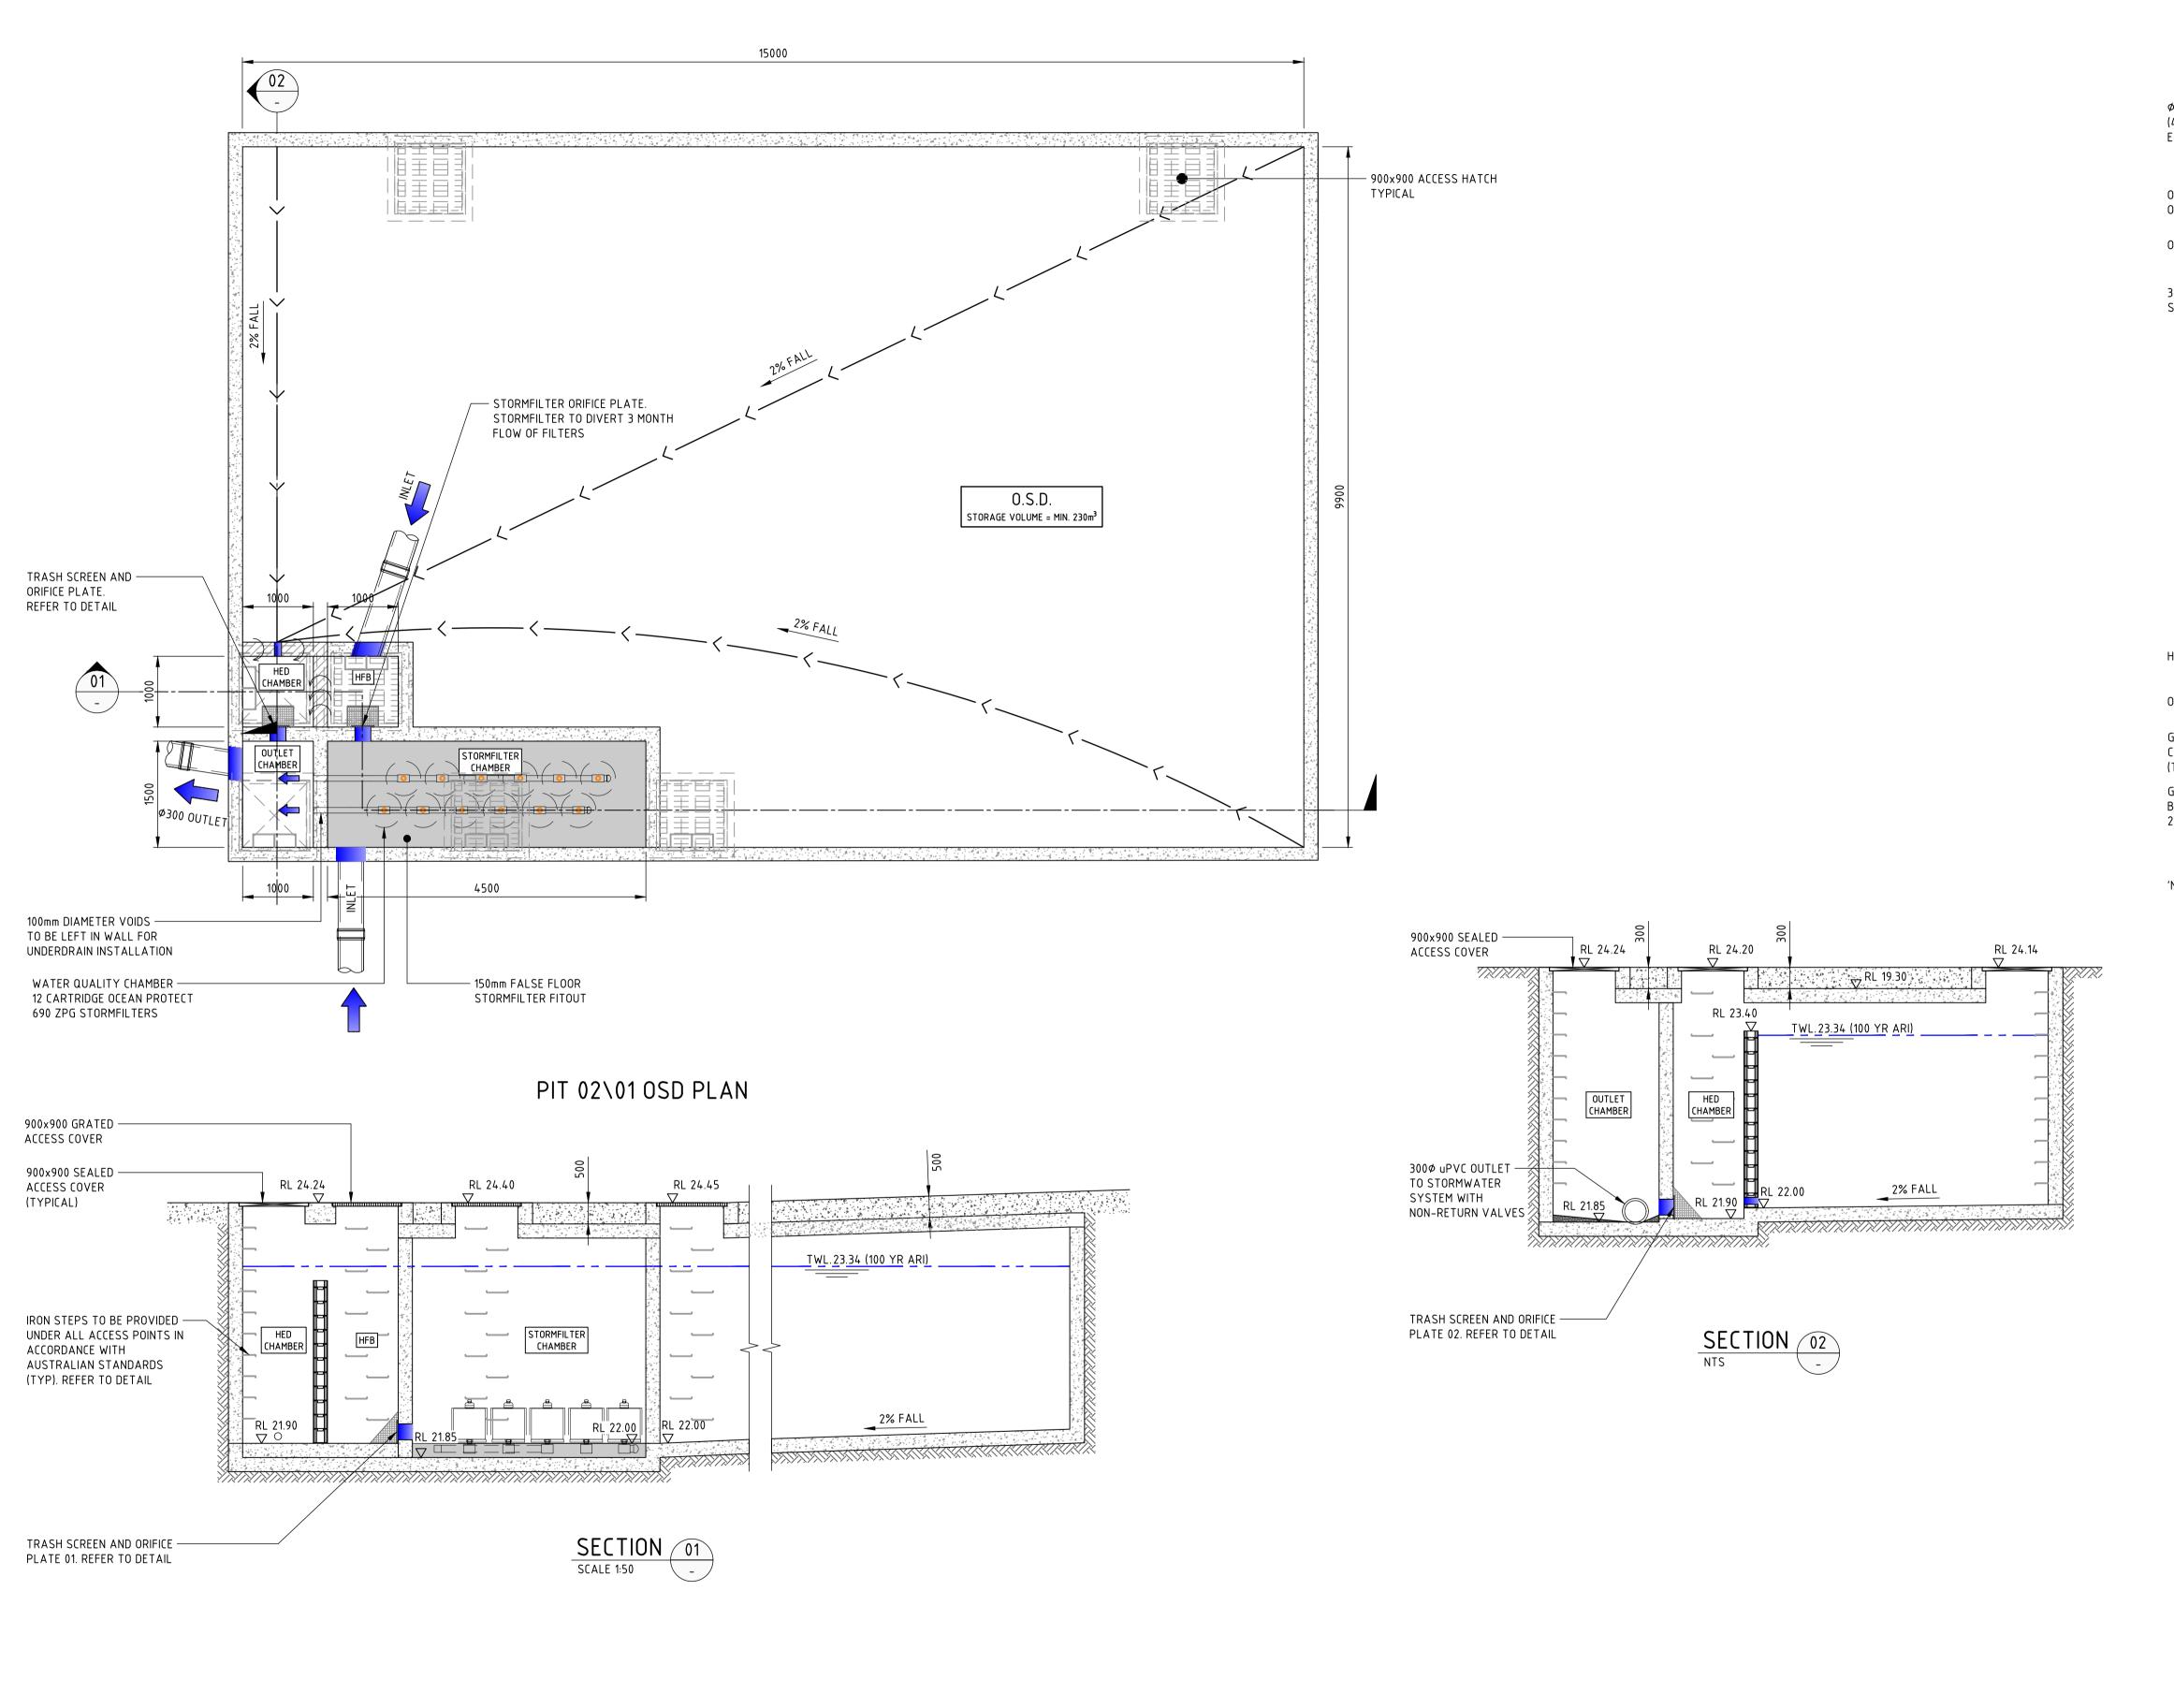


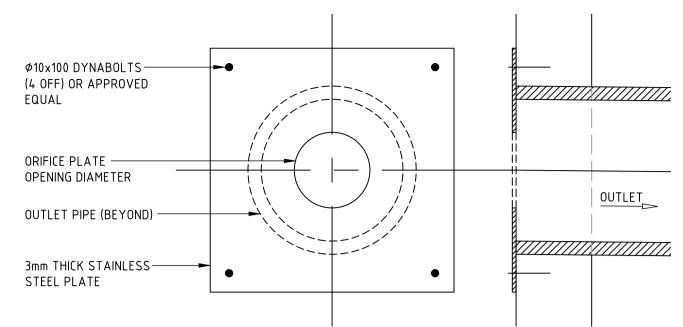

ORIFICE PLATE DETAIL ORIFICE PLATE – Φ 114mm

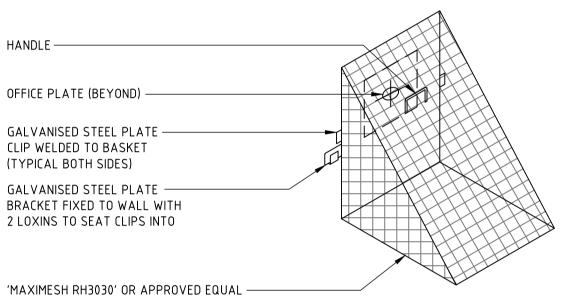

TRASH SCREEN DETAIL

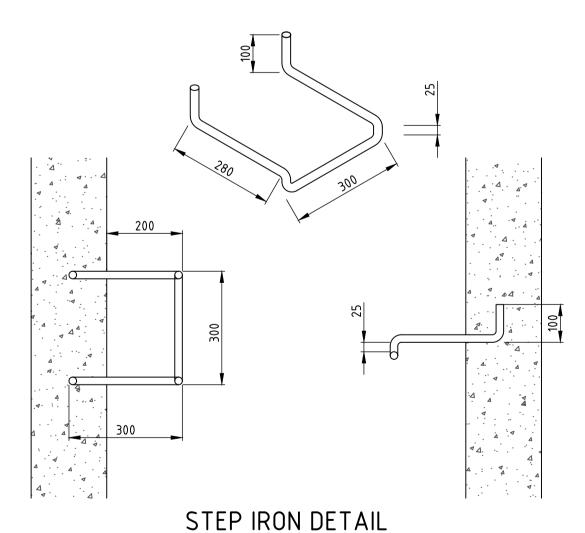

STEP IRON OF 20mm GALVANISED STEEL MADE TO SHAPE AND DIMENSIONS AS SHOWN, PLACED AT 300 CENTRES AND STAGGERED HORIZONTALLY FOR ALL PITS DEEPER THAN 1.0m. THE USE OF PROPRIETARY STEP IRONS ARE ACCEPTABLE PROVIDED THE PRODUCT IS IN ACCORDANCE WITH AUSTRALIAN STANDARDS



NOT FOR CONSTRUCTION

REVISION	DESCRIPTION	ISSUED	VER'D	APP'D	DATE	CLIENT
1	ISSUED FOR DA	ТВ		NN	27.03.20	•
2	ISSUED FOR DA	AS		NN	01.04.20	
						•
						DRAWING NOT TO BE USED FOR CONSTRUCTION UNLI
						VERIFICATION SIGNATURE HAS BEEN ADDED

ARCHITECT THE COPYRIGHT OF THIS DRAWING REMAINS WITH

NORTHROP CONSULTING ENGINEERS PTY LTD

Commencing Work. NORTHROP ACCEPTS NO RESPONSIBILITY FOR THE USABILITY, COMPLETENESS OR SCALE OF DRAWINGS TRANSFERRED ELECTRONICALLY.
THIS DRAWING MAY HAVE BEEN PREPARED USING COLOUR,
AND MAY BE INCOMPLETE IF COPIED TO BLACK & WHITE

SCALE VARIES



Level 11 345 George Street, Sydney NSW 2000 Ph (02) 9241 4188 Fax (02) 9241 4324 Email sydney@northrop.com.au ABN 81 094 433 100

WESTMEAD CATHOLIC COMMUNITY DARCY ROAD, WESTMEAD


CARPARK

DRAWING TITLE **CIVIL DOCUMENTATION**

> STORMWATER MANAGEMENT **DEVICES**

192734 DRAWING NUMBER


REVISION DAC104.31 DRAWING SHEET SIZE = A1

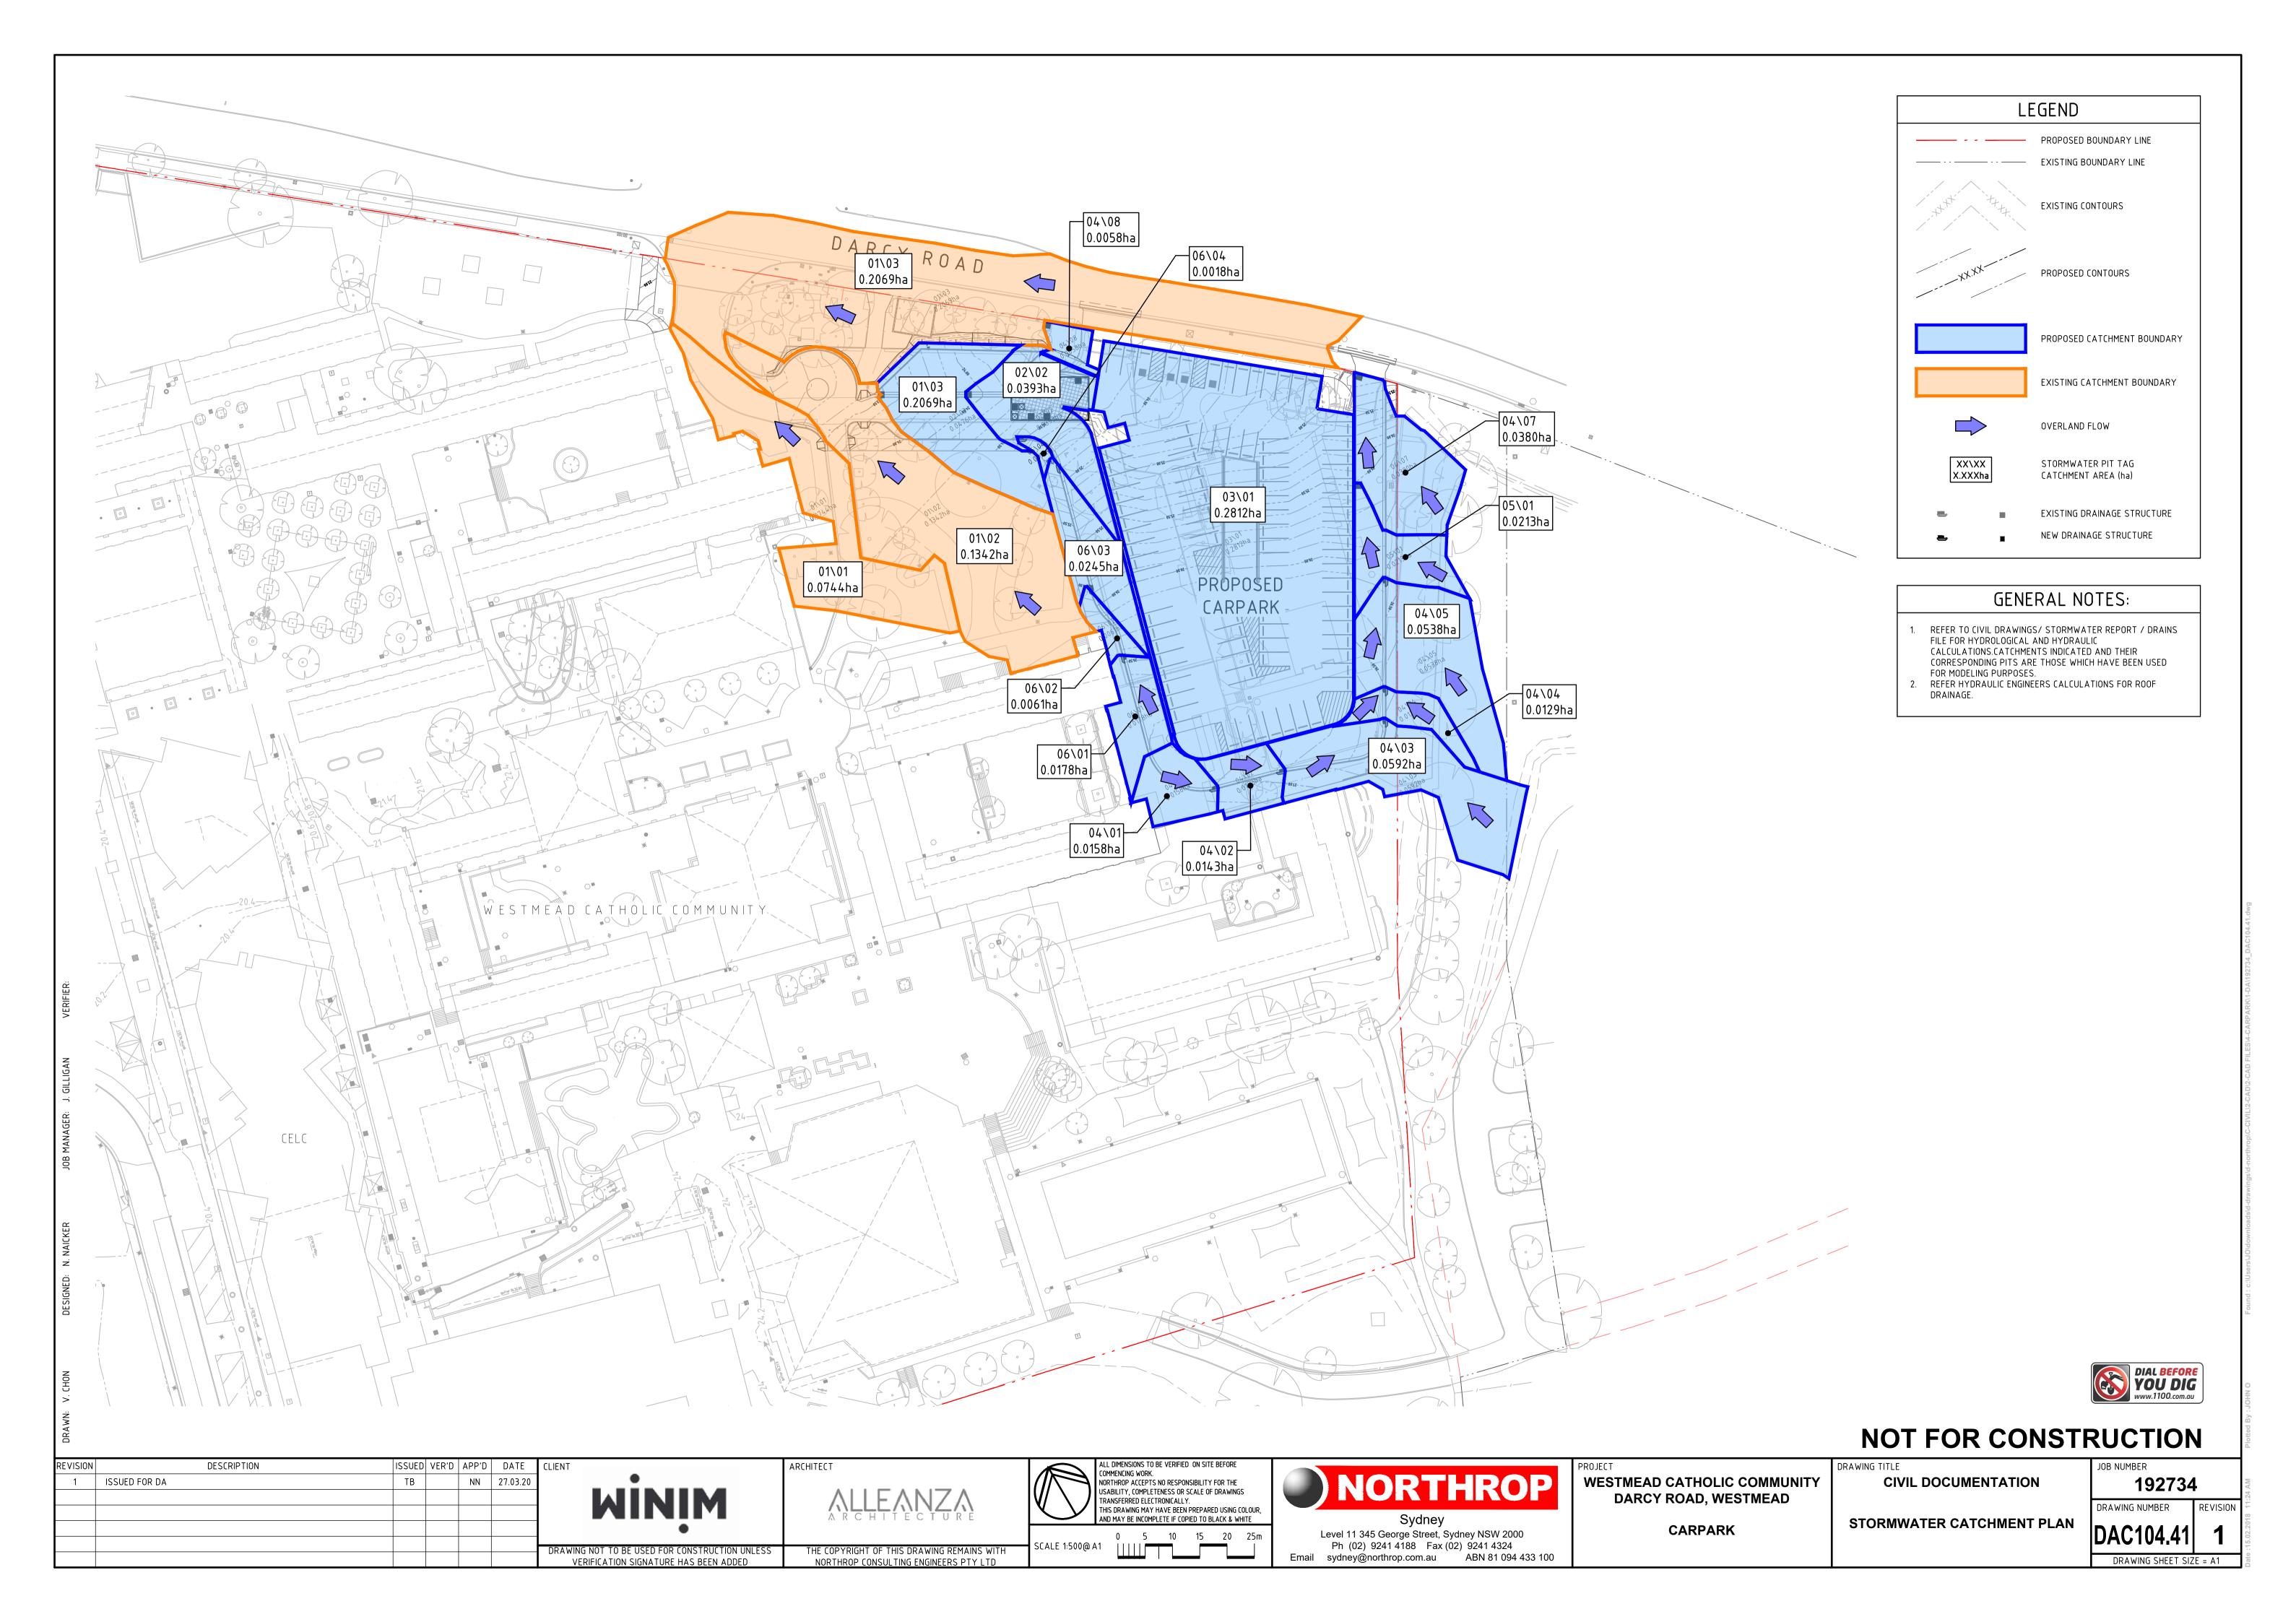

KERB ONLY 'KO'

EXPANSION JOINTS @ MAX 12m CTRS / TOOL JOINTS @ MAX 3m CTRS ALL RADII TO BE 20mm U.N.O.


NOTE: REFER TO GEOTECHNICAL REPORT FOR PAVEMENT SPECIFICATION

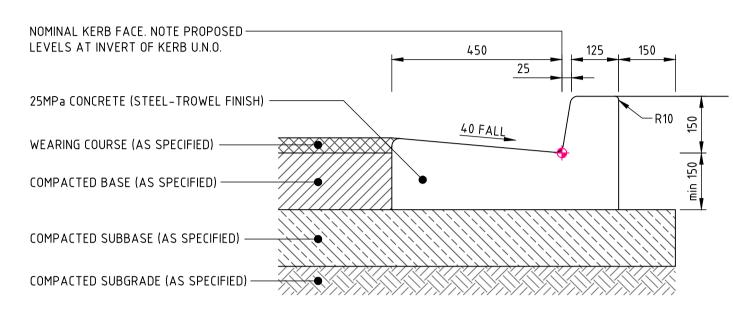

KERB & GUTTER 'KG'

EXPANSION JOINTS @ MAX 12m CTRS / TOOL JOINTS @ MAX 3m CTRS ALL RADII TO BE 20mm U.N.O.


NOTE: REFER TO GEOTECHNICAL REPORT FOR PAVEMENT SPECIFICATION

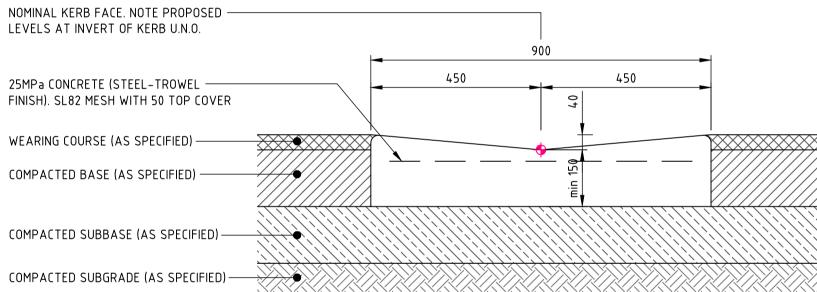

DISH DRAIN - 900 WIDE 'DD'


EXPANSION JOINTS @ MAX 12m CTRS / TOOL JOINTS @ MAX 3m CTRS ALL RADII TO BE 20mm U.N.O.

NOTE: REFER TO GEOTECHNICAL REPORT FOR PAVEMENT SPECIFICATION

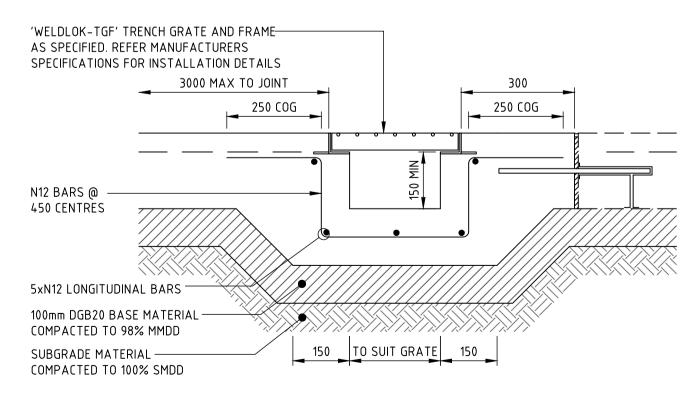


GRATED TRENCH DRAIN 'GTD'


GRATED TRENCH DRAIN TO HAVE MINIMUM 150mm CLEARANCE AND 1% LONGITUDINAL FALL. GRATE CLASS TO BE CLASS 'B' HEELSAFE IN PEDESTRIAN AREAS AND CLASS 'D' IN TRAFFICKED AREAS UNLESS NOTED OTHERWISE ON PLAN. REFER PLAN FOR JOINT TYPES AND LOCATIONS

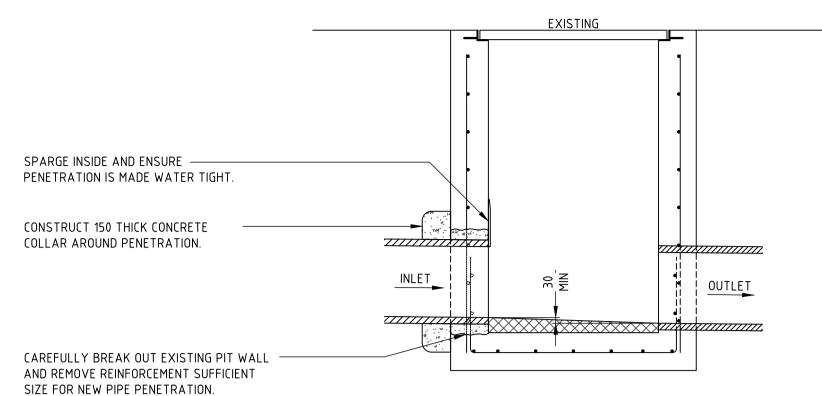

DRAINAGE PIT - NEW PIPE CONNECTION

THE CONTRACTOR SHALL REQUEST THE SUPERINTENDENT INSPECT THE CONDITION OF THE EXISTING PIT PRIOR TO MODIFICATION. IF THE EXISTING PIT IS IN POOR CONDITION, THE CONTRACTOR SHALL REMOVE AND RECONSTRUCT A NEW PIT IN ACCORDANCE WITH SUPERINTENDENTS INSTRUCTIONS.

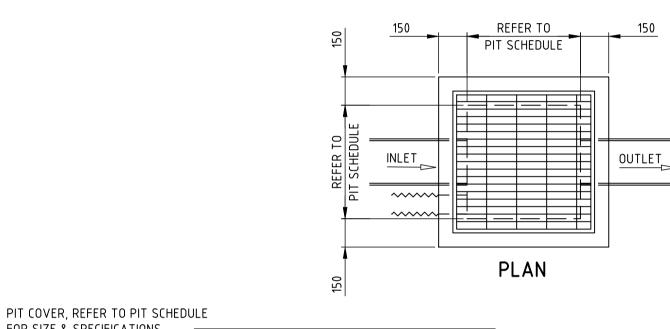

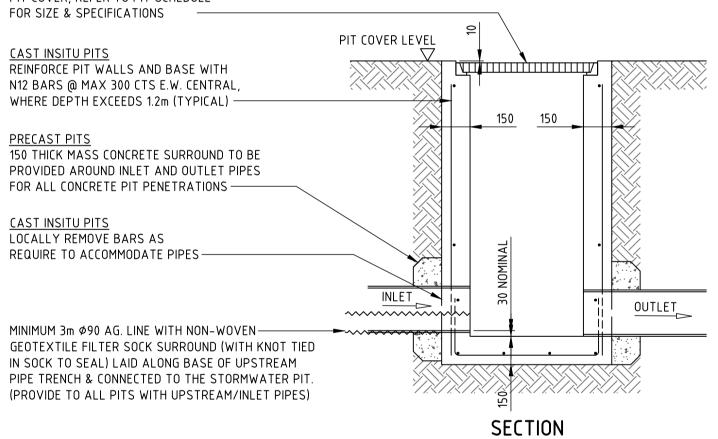

HEAVY DUTY STORMWATER PIT (FOR PIPES Ø600 OR LESS & DEPTHS 2.0m OR LESS)

NOTE: - PROVIDE STEP IRONS IN ACCORDANCE WITH AS1657 WHEN DEPTH IS GREATER THAN 1200mm - SPARGE INTERNAL PIT FACE AT ALL PIPE PENETRATIONS - SHAPE BASE OF PIT TO DIRECT FLOWS TO OUTLET - PROVIDE ADEQUATE LEVEL OF COMPACTION AROUND PIT. REFER TO SPECIFICATION FOR REQUIREMENT.



NOT FOR CONSTRUCTION

DESCRIPTION REVISION 1 ISSUED FOR DA NN 27.03.20 TB

DRAWING NOT TO BE USED FOR CONSTRUCTION UNLESS VERIFICATION SIGNATURE HAS BEEN ADDED

ARCHITECT

Commencing Work. NORTHROP ACCEPTS NO RESPONSIBILITY FOR THE USABILITY, COMPLETENESS OR SCALE OF DRAWINGS TRANSFERRED ELECTRONICALLY. THIS DRAWING MAY HAVE BEEN PREPARED USING COLOUR,
AND MAY BE INCOMPLETE IF COPIED TO BLACK & WHITE

Sydney Level 11 345 George Street, Sydney NSW 2000

WESTMEAD CATHOLIC COMMUNITY DARCY ROAD, WESTMEAD

CARPARK

DRAWING TITLE **CIVIL DOCUMENTATION**

DETAILS - SHEET 01

192734 DRAWING NUMBER REVISION

DAC107.01 DRAWING SHEET SIZE = A1


ISSUED VER'D APP'D DATE


THE COPYRIGHT OF THIS DRAWING REMAINS WITH

NORTHROP CONSULTING ENGINEERS PTY LTD

SCALE VARIES

Ph (02) 9241 4188 Fax (02) 9241 4324 Email sydney@northrop.com.au ABN 81 094 433 100

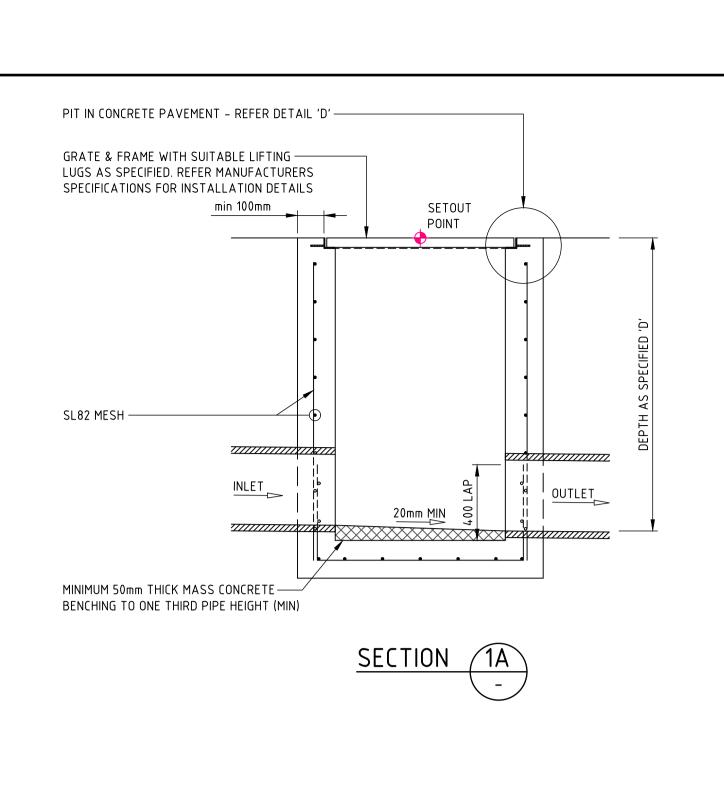


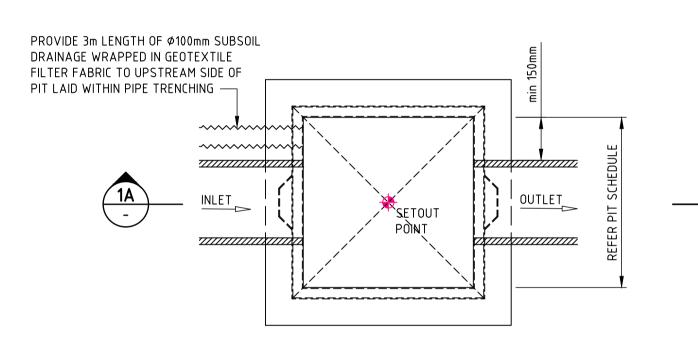


PLAN SURFACE INLET 'SIP' / JUNCTION PIT 'JP' PIT STRUCTURE TO BE 200mm THICK UNLESS SHOWN OTHERWISE, DRILL AND EPOXY PLASTIC PROPRIETARY STEP IRONS IN ACCORDANCE WITH AUSTRALIAN STANDARDS AND


MANUFACTURERS SPECIFICATIONS (PITS > 1000mm DEPTH).

REFER PIT INTERFACE DETAIL 'F' FOR CORNER REINFORCEMENT

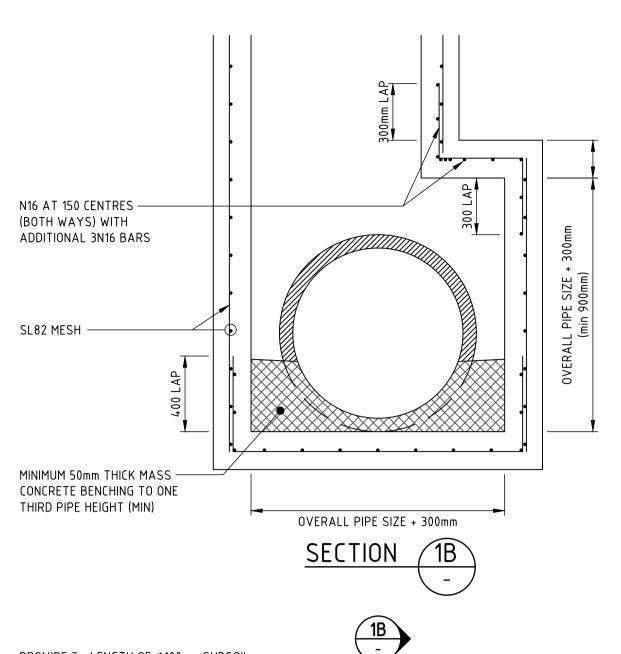

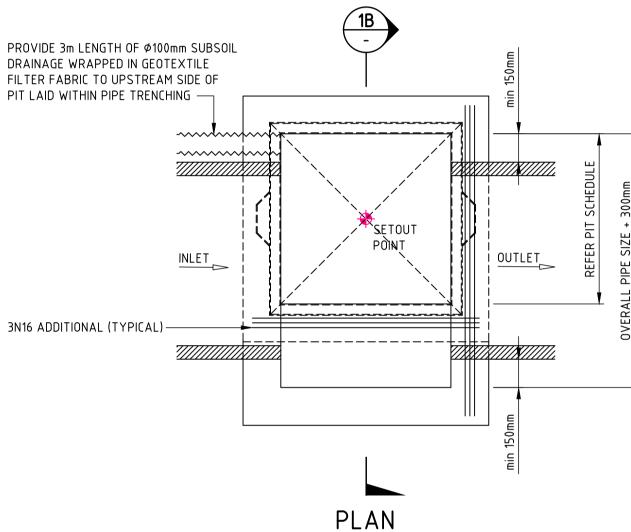

DRAINAGE PIT – EXTENDED CHAMBER PIT STRUCTURE TO BE 200mm THICK UNLESS SHOWN OTHERWISE. DRILL AND EPOXY PLASTIC PROPRIETARY STEP IRONS IN ACCORDANCE WITH AUSTRALIAN STANDARDS AND MANUFACTURERS SPECIFICATIONS (PITS > 1000mm DEPTH). REFER PIT INTERFACE DETAIL 'F' FOR CORNER REINFORCEMENT

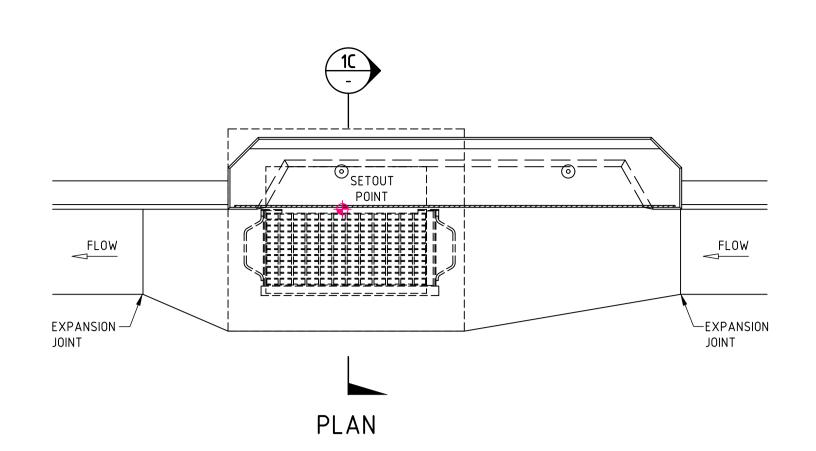


CENTRAL TO PIT GRATE AND FRAME AND 1:10 CHUTE IS CONSTRUCTED TO BOTH SIDES OF PIT


FOR SAG PITS, ENSURE PIT LINTEL IS LOCATED


REFER EXTENDED CHAMBER PIT DETAIL FOR PIPEWORK IN EXCESS OF \$\phi450\$ AND WHERE REQUIRED

PRECAST REINFORCED CONCRETE ——

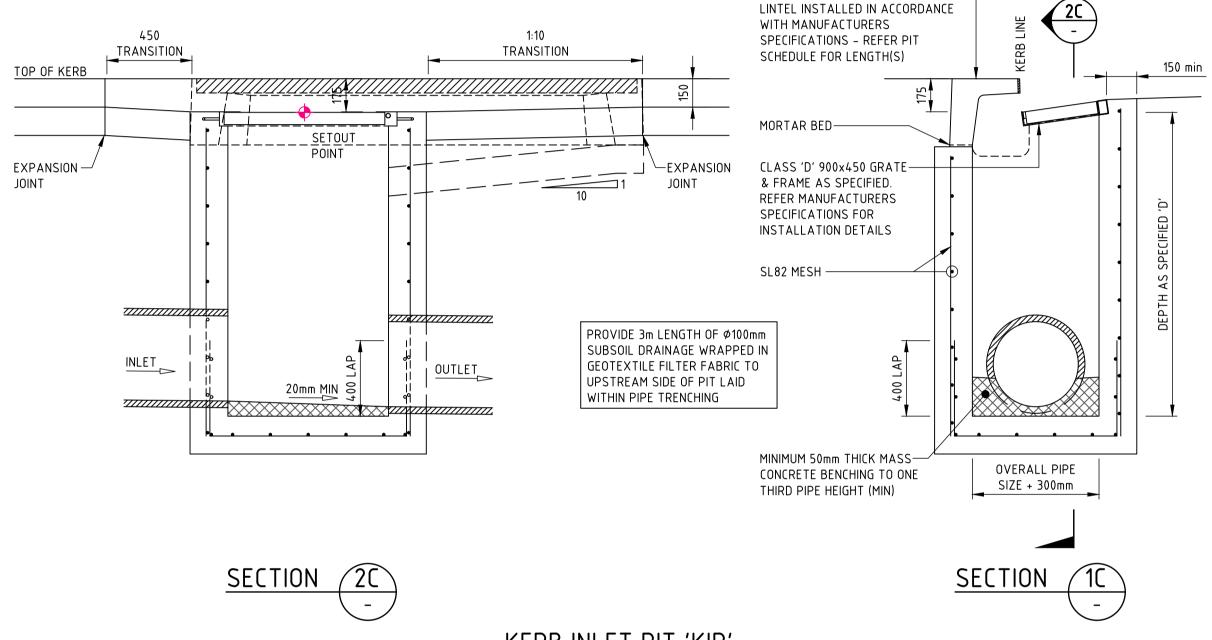

KERB INLET PIT 'KIP' PIT STRUCTURE TO BE 200mm THICK UNLESS SHOWN OTHERWISE. DRILL AND EPOXY PLASTIC PROPRIETARY STEP IRONS IN ACCORDANCE WITH AUSTRALIAN STANDARDS AND MANUFACTURERS SPECIFICATIONS (PITS > 1000mm DEPTH). REFER PIT INTERFACE DETAIL 'F' FOR CORNER REINFORCEMENT

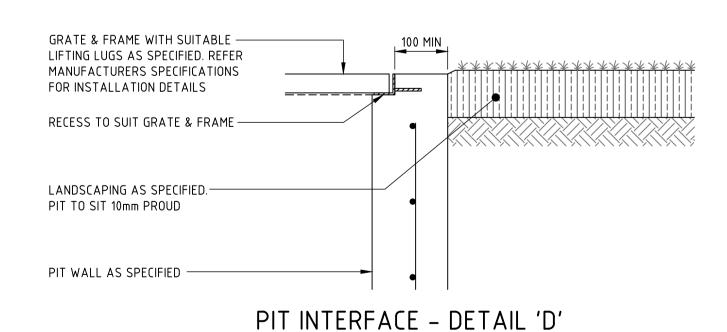

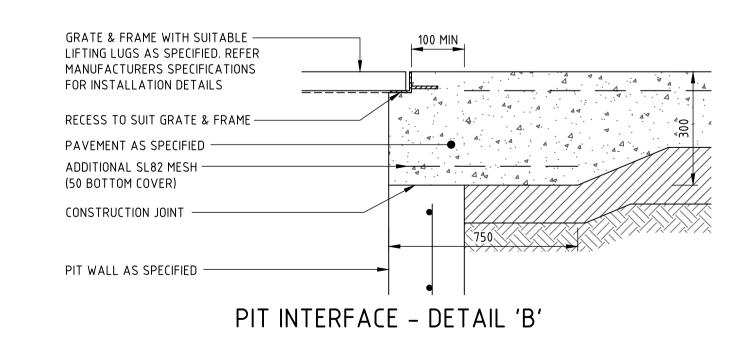



NOT FOR CONSTRUCTION

REVISION	DESCRIPTION	ISSUED	VER'D	APP'D	DATE	CLIE
1	ISSUED FOR DA	ТВ		NN	27.03.20	1
						1
						1
						1
						DF

DRAWING NOT TO BE USED FOR CONSTRUCTION UNLESS VERIFICATION SIGNATURE HAS BEEN ADDED

ARCHITECT

Commencing Work. NORTHROP ACCEPTS NO RESPONSIBILITY FOR THE USABILITY, COMPLETENESS OR SCALE OF DRAWINGS TRANSFERRED ELECTRONICALLY. THIS DRAWING MAY HAVE BEEN PREPARED USING COLOUR,
AND MAY BE INCOMPLETE IF COPIED TO BLACK & WHITE



Level 11 345 George Street, Sydney NSW 2000 Ph (02) 9241 4188 Fax (02) 9241 4324 Email sydney@northrop.com.au ABN 81 094 433 100

WESTMEAD CATHOLIC COMMUNITY DARCY ROAD, WESTMEAD

CARPARK

DRAWING TITLE

CIVIL DOCUMENTATION DETAILS - SHEET 02

192734 DRAWING NUMBER REVISION

DAC107.02 DRAWING SHEET SIZE = A1

SCALE VARIES THE COPYRIGHT OF THIS DRAWING REMAINS WITH NORTHROP CONSULTING ENGINEERS PTY LTD